



00186534202410124130660668

SHAWNYNE GARREN, RECORDER

Recording Requested By:

Name: Nicole Hubbard

Department: Public Works

United States Department of the Interior - Right of Way Grant -
Mountain View Water Storage Tanks

(Title of Document)

UNITED STATES
DEPARTMENT OF THE INTERIOR
BUREAU OF LAND MANAGEMENT

RIGHT-OF-WAY GRANT/TEMPORARY USE PERMIT

Issuing Office
Sierra Front Field Office

Serial Number
NVN 045053

1. A (right-of-way) (permit) is hereby granted pursuant to:

- a. Title V of the Federal Land Policy and Management Act of October 21, 1976 (90 Stat. 2776; 43 U.S.C. 1761);
- b. Section 28 of the Mineral Leasing Act of 1920, as amended (30 U.S.C. 185);
- c. Other (describe) _____

2. Nature of Interest:

a. By this instrument, the holder Douglas County receives a right to construct, operate, maintain, and terminate a 2 water tank and access road on public lands (or Federal land for MLA Rights-of-Way) described as follows:

Within the following described lands:

Mount Diablo Meridian, Nevada

**T. 14 N., R. 20 E.,
Sec. 21, SESE;
Sec. 22, SWSW;
Sec. 27, NWNW.**

b. The right-of-way or permit area granted herein is 450 feet wide, 589 feet long and contains 6.36 acres, more or less. If a site type facility, the facility contains _____ acres.

c. This instrument shall terminate on December 31, 2054, _____ years from its effective date unless, prior thereto, it is relinquished, abandoned, terminated, or modified pursuant to the terms and conditions of this instrument or of any applicable Federal law or regulation.

d. This instrument may may not be renewed. If renewed, the right-of-way or permit shall be subject to the regulations existing at the time of renewal and any other terms and conditions that the authorized officer deems necessary to protect the public interest.

e. Notwithstanding the expiration of this instrument or any renewal thereof, early relinquishment, abandonment, or termination, the provisions of this instrument, to the extent applicable, shall continue in effect and shall be binding on the holder, its successors, or assigns, until they have fully satisfied the obligations and/or liabilities accruing herein before or on account of the expiration, or prior termination, of the grant.

3. Rental:

For and in consideration of the rights granted, the holder agrees to pay the Bureau of Land Management fair market value rental as determined by the authorized officer unless specifically exempted from such payment by regulation. Provided, however, that the rental may be adjusted by the authorized officer, whenever necessary, to reflect changes in the fair market rental value as determined by the application of sound business management principles, and so far as practicable and feasible, in accordance with comparable commercial practices.

4. Terms and Conditions:

- a. This grant or permit is issued subject to the holder's compliance with all applicable regulations contained in Title 43 Code of Federal Regulations parts 2800 and 2880.
- b. Upon grant termination by the authorized officer, all improvements shall be removed from the public lands within 120 days, or otherwise disposed of as provided in paragraph (4)(d) or as directed by the authorized officer.
- c. Each grant issued pursuant to the authority of paragraph (1)(a) for a term of 20 years or more shall, at a minimum, be reviewed by the authorized officer at the end of the 20th year and at regular intervals thereafter not to exceed 10 years. Provided, however, that a right-of-way or permit granted herein may be reviewed at any time deemed necessary by the authorized officer.
- d. The stipulations, plans, maps, or designs set forth in Exhibit(s) A, dated December 2023, attached hereto, are incorporated into and made a part of this grant instrument as fully and effectively as if they were set forth herein in their entirety.
- e. Failure of the holder to comply with applicable law or any provision of this right-of-way grant or permit shall constitute grounds for suspension or termination thereof.
- f. The holder shall perform all operations in a good and workmanlike manner so as to ensure protection of the environment and the health and safety of the public.

Exhibit A: Plan of Development dated December 2023
Exhibit B: Construction Drawings dated July 2024
Exhibit C: Additional Terms and Conditions

IN WITNESS WHEREOF, The undersigned agrees to the terms and conditions of this right-of-way grant or permit.

[Signature]
 (Signature of Holder)
Deputy Director - Public Works
 (Title)
8/30/24
 (Date)

[Signature]
 (Signature of Authorized Officer)
Acting Field Manager
 (Title)
9/4/2024
 (Effective Date of Grant)

Exhibit A

Mountain View Water Storage Tank Amendment to N-45053 Plan of Development

Purpose and Need for the Facility

Douglas County owns and operates the existing ±600,000-gallon Mountain View potable water storage tank which is located on BLM land (grant N-45053). The tank currently serves ±671 equivalent dwelling units (EDUs) and is estimated to serve ±832 EDUs at build out of the service area. However, the tank is approximately 35 years old, undersized, doesn't meet current design standards, and is reaching the end of its useful life. Photos of the existing tank and access road are shown in Figure 1.

To address these deficiencies, Douglas County proposes constructing two permanent ±565,000-gallon (nominal) water storage tanks at the same site to replace the existing Mountain View tank. The tanks will be used to store water to meet potable, emergency, and firefighting demands. Table 1 provides a summary of dimensions and details for the proposed tanks.

Table 1 – Proposed Tank(s) Details

Number of Tanks	2
Construction Material	Welded Steel
Diameter	66-feet
Tank Height	27.65-feet
Tank Overflow Height	23-feet
Operating Water Depth	22-feet
Operating Volume per Tank	563,000
Total Operating Volume (2 Tanks)	1,126,000

The following work is also anticipated as part of the proposed project:

- Construction of ±210-feet of underground potable water pipe to connect the new water tanks to the existing water line.
- Construction of ±144-feet of underground water pipe to drain the new water tanks.
- Construction of a drain water retention basin.
- Construction of electrical conduit between the tanks and the existing electrical cabinets.
- Realignment of ±3,400 square feet of approach road.
- Regrading of ±2,800 linear feet of existing access road.
- Construction of ±1,1450 square yards of asphalt site pavement

The engineer's opinion of probable cost for the project is \$5,510,000. A map showing the location of the existing tank and proposed tanks is shown in Figure 2.

As part of the preliminary design, three additional tank replacement alternatives were considered. These include 1) constructing a new tank at the existing tank site (\$5,860,000), 2) constructing a new tank at a new site north of the existing tank (\$5,950,000), and 3) phasing construction of two new tanks at the existing site (\$6,120,000). The rejected alternatives were not chosen because they had higher capital costs and were more difficult to construct.

Right-of-Way Location

Figure 3 shows the location of the proposed amended BLM permit area, the current BLM permit area, and the pre-existing access road. A summary of the area and dimensions are shown in the following table.

Table 2 – Permit Area and Dimensions (longest)

	Area (acres)	Length (ft)	Width (ft)
Existing BLM Grant N-45053	6.36	740 (longest)	450 (longest)
Proposed Permit Area	7.49	662 (longest)	648 (longest)
Proposed Access Road Area	1.70	2,475	30

Please note that Douglas County will hire a Professional Land Surveyor to prepare the legal description(s) when the final BLM permit area is defined.

Facility Design Factors

The proposed project is being designed by Keller Associates, an engineering firm licensed in the State of Nevada, and overseen by the Douglas County Public Works Engineering Department. The work is being designed to meet the codes established in Nevada Administrative Code 445A, the standards established in the Douglas County Design Standards, specifications established in the *Standard Specifications for Public Works Construction (Orange Book)*, the American Water Works Association (AWWA) *Manual of Water Supply Practices M42 Steel Water Storage Tanks*, and AWWA Standard D100. All construction materials will be in compliance with AWWA standards and NSF 61 certified ensuring that water entering/leaving the project will be safe for human consumption.

New underground water pipelines will be primarily constructed using AWWA C900 DR18 PVC pipe (pressure class 235 psi) and/or AWWA C151 ductile iron pipe (pressure class 350 psi). Anticipated pipe pressures range from 0 psi (empty pipe) to ±12 psi (full tank). Pipe will be buried at minimum 42-inches underground.

The realigned approach road (±3,640 square feet) to the tank site will be gravel on native soils. The existing access road (±2,800-feet by ±15-feet) will remain native soils and follow the existing contours. No bridges, or water crossings are needed on the existing access road or the realigned approach road. One culvert will be installed as part of the drain water retention basin construction.

It is anticipated that the Contractor will be able to stage construction materials and equipment adjacent to the existing water storage tank. No other BLM property will be approved for staging, further development, or installation of temporary facilities.

Additional Components of Right-of-Way

At this time there are no additional project components other than detailed in other sections of the POD.

Site Selection

No site selection evaluation was completed due to the existing water tank on the site.

Government Agencies Involved

The following permits, rights-of-way, etc. are anticipated for the project:

- BLM grant or right-of-way
- Nevada Division of Environmental Protection Bureau of Safe Drinking Water Permit to Construct
- Douglas County Site Improvement Permit
- East Fork Fire Protection District Permit

Douglas County Public Works is managing the project from preliminary design through construction and will own and operate the proposed new tanks. No other direct Federal, State, Local, or Tribal Government involvement is anticipated.

Construction of the Facilities

Construction of the proposed new tanks will likely occur in the following phases:

Phase 1 – Site Grading. In this phase the BLM grant/ROW and work area will be staked, the contractor will excavate and grade the site to allow for construction of the new tanks, and realignment of the approach road. In this phase it is estimated that ±4,633 cubic yards of cut material will be removed from the site. During this phase it is anticipated to have heavy equipment grading the site and dump trucks hauling cut material from the site for several weeks.

Phase 2 – Civil Site Work. In this phase water pipeline and drain line will be constructed for both new tanks. This phase will likely require an excavator and loader/backhoe to complete the work.

Phase 3 – Tank 1 Construction. In this phase tank 1 will be constructed, tested, and brought into service. Tank construction crews typically consist of 3 to 5 workers and a fork lift (or similar) and coating crews typically consist of 2 to 4 workers with minor onsite equipment.

Phase 4 – Existing Tank Demolition. During this phase the existing tank will be demolished and removed from the project site. Some site grading will be completed to prepare the site for construction of tank 2. To complete the work the contractor will likely rely on a forklift (or similar) to demolish the tank and heavy earth moving equipment to grade the site for tank 2.

Phase 5 – Tank 2 Construction. In this phase tank 2 will be constructed, tested, and brought into service. Tank construction crews typically consist of 3 to 5 workers and a fork lift (or similar) and coating crews typically consist of 2 to 4 workers with minor onsite equipment.

Phase 6 – Site Cleanup. During this phase the site fence will be constructed and all ground surfaces will be finished (i.e. gravel approach road and site paving). In addition, the contractor will clean the site and demobilize all non-permanent equipment and materials. This phase will require various equipment.

It is anticipated that the project will take 12-months to complete all six phases of the construction. The contractor will be confined to the approved BLM grant/ROW.

Access to the site will be along the existing north-south access road. Ingress/egress to BLM lands and the existing access road is off Porter Drive. The contractor will be required to have and implement a safety program while working on the site.

No industrial waste or toxic substances will be used, generated, discharged, or left on the project site.

Resource Values and Environmental Concerns

Air – The proposed project will not lead to any permanent deterioration in air quality. However, it may lead to temporary, localized deterioration in air quality due to the use of heavy equipment, excavation, and grading required to complete the work.

Noise – The proposed project will not lead to any permanent changes in noise. However, it may lead to temporary, localized increase in noise due to the use of heavy equipment, excavation, and grading required to complete the work. Douglas County code does limits work to 7:00AM to 7:00PM.

Geological Hazards – No known geological hazards exist at the project site.

Mineral and Energy Resources – No known mineral and energy resources exist at the project site.

Paleontological Resources – No known paleontological resources exist at the project site.

Soils – The proposed permit area consists of primarily Incy fine sand (4 to 30% slopes) with the very southeast corner of the area consisting of Koontz-Stodick-Flex Association. The access road area consists of Incy fine sand (4 to 30% slopes) and Toll sand (0 to 4% slopes). None of the soils present is considered prime farmland (websoilsurvey.nrcs.usda.gov/app/).

Water – There are no blue line streams in the vicinity of the project area.

Threatened and Endangered Species – Table 3 list threatened or endangered species that may exist in the vicinity of the project. No critical habitat is identified in the vicinity of the project (ipac.ecosphere.fws.gov/location/index).

Table 3 – Threatened and Endangered Species

Greater Sage-grouse	Proposed Threatened
Northwestern Pond Turtle	Proposed Threatened
Carson Wandering Skipper	Endangered
Monarch Butterfly	Candidate

Cultural Resources – No known cultural resources exist at the project site.

Visual Resources – No known visual resources exist at the project site. However, there is an existing water tank at the project site.

BLM Projects – No known BLM projects exist at the project site.

Recreation Activities – Land adjacent to the project site is used for off highway vehicles (OHVs), hikers, and other recreational uses. The proposed project will have limited impact on public access to BLM lands.

Wilderness – There are no wilderness or wilderness study areas at the project site.

Stabilization and Rehabilitation

Disturbed soils will be reseeded with native vegetation. Seeding specifications will be developed as the project design progresses.

Trash, debris, rubbish, and other garbage generated during construction will be regularly collected by the contractor and hauled offsite for proper disposal (likely the Douglas County transfer station).

Public access to the tank site will be limited but the access road will continue to be open to the general public.

Operation and Maintenance

The Douglas County Public Works Department employs nine licensed water distribution operators and three Professional Engineers that specialize in potable water. Operations staff complete exterior tank inspections on a monthly basis and interior inspections (using a diver) every 3-years. These inspections take place during the work week between 7:30AM and 4:00PM. Operations and maintenance will be performed in accordance with County safety procedures. Operations and maintenance activities will be confined within the approved BLM grant/ROW.

The tank site will be accessed by the existing access road previously described. The tank site will be signed and fenced with anti-intruder chain link fencing (chain link with barb wire along the top). The fence will be installed to deter public access to the actual tank site for the safety of the public and to deter bad actors from vandalizing the tank site or disrupting operation of the water system. Access to the fenced tank site will be primarily limited to Public Works staff. However, BLM, regulators, and subcontractors will be admitted to the site by Public Works on an as-needed basis.

The tanks will be equipped with instrumentation and controls that will trigger a pump station (not located on BLM lands) to turn on to fill the tank and turn off when the tank has reached its operational level. Level transmitters will be used to monitor the water level in each tank and a back up float switch will be installed to turn off the pump station if the level transmitter fails. This redundant configuration will significantly reduce the risk of a tank overflow. Tank water levels and pump station status can be monitored remotely through the Public Works supervisory control and data acquisition (SCADA) system.

The new tanks and pipelines will be hydrostatically tested and disinfected using potable water from the County's distribution system. Disinfection water will be dechlorinated prior to release, in accordance with AWWA standards. The anticipated volume of water released is 1.13 million gallons

The tanks will be constructed of welded steel and do not pose a fire risk to the tank site. However, the tanks will improve fire fighting ability in the Johnson Lane area by increasing the volume of stored water available in an emergency.


In addition to being easier to construct, two tanks will provide redundancy for the water system and will be easier to service and repair in the future.

Termination and Restoration


The tank site is considered permanent and will serve the public for many years. There are no plans to terminate use of the tank site. Two tanks are being installed for numerous reasons including to meet future demand, provide additional firefighting capability, and to simplify future repairs and rehabilitation of the tanks (i.e. one tank can be taken offline for rehabilitation while the other tank stays in service).




Figure 1 – Site Photos

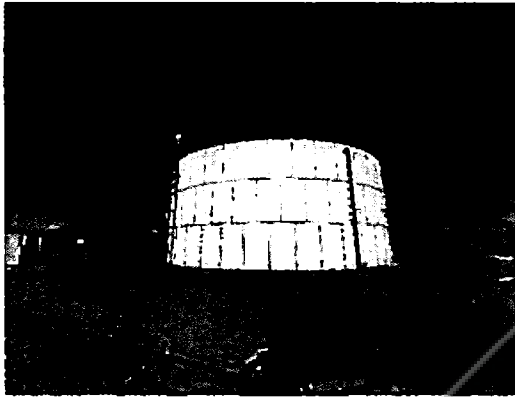

Existing tank looking north

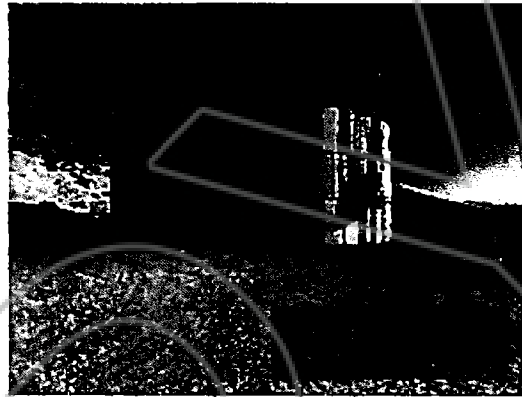

Existing tank looking south

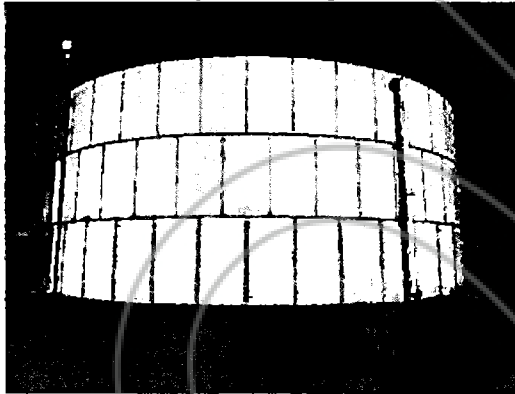


Existing tank looking northeast



Existing tank and fence



Existing access road looking north towards tank

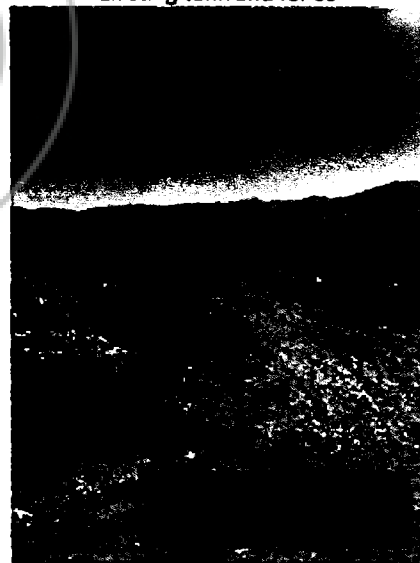

Existing access road looking south from near tank

Figure 2 – Location Map

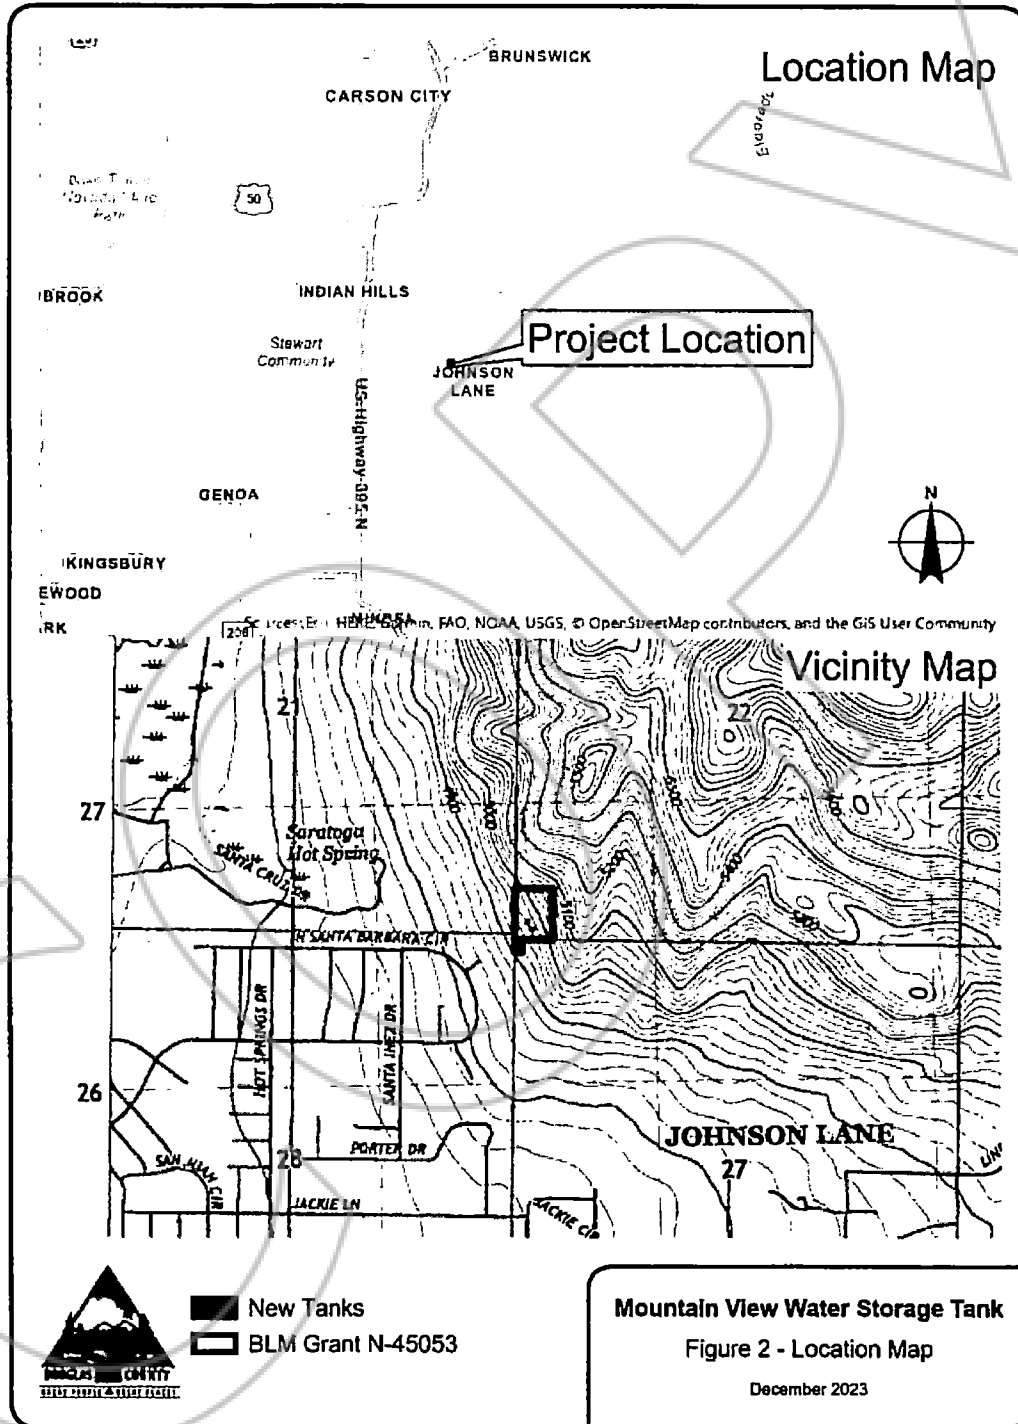


Figure 3 – Proposed BLM Permit Area



Exhibit B

DOUGLAS COUNTY, NV MOUNTAIN VIEW RESERVOIR REPLACEMENT

JULY 2024

DOUGLAS COUNTY
COUNTY ENGINEER

DATE



3/6 Design
Review
Not For
Construction


NO REVISIONS
DATE
THIS DRAWING IS THE PROPERTY OF KELLER ASSOCIATES. IT IS TO BE USED ONLY FOR THE PROJECT AND SITE SPECIFICALLY IDENTIFIED HEREIN. ANY REUSE OR MODIFICATION OF THIS DRAWING WITHOUT THE WRITTEN PERMISSION OF KELLER ASSOCIATES IS PROHIBITED.



DOUGLAS COUNTY, NEVADA

MOUNTAIN VIEW WATER TANK REPLACEMENT
TITLE SHEET

DRAWN	JH/CHK	JW
VERIFY SCALE. Scales based on 22x34" prints.		
PROJECT NO.	223125	PAGE
1-1/2" SCALE		
SHEET NO. G-001		

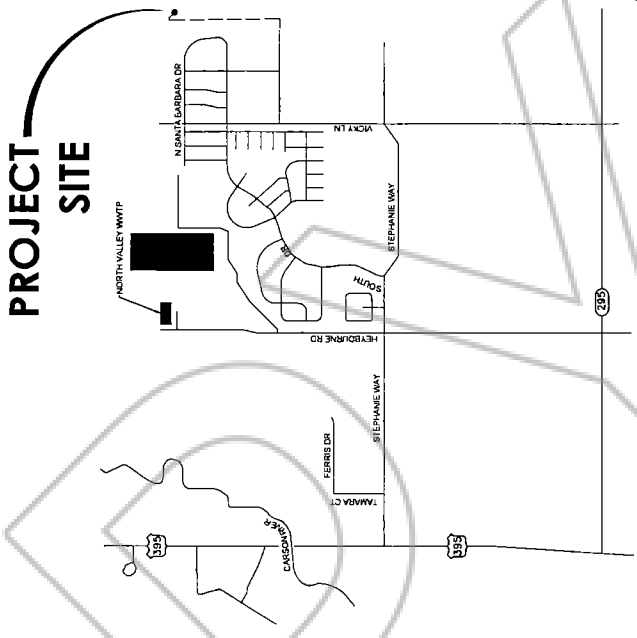

BASIS OF BEARINGS

COORDINATES AND BEARINGS ARE BASED UPON THE NEVADA STATE PLANE COORDINATE SYSTEM, NAD 83/04 ADJUSTED TO GROUND VALUES, AS ESTABLISHED BY A SURVEY OF THE STATE PLANE COORDINATE NETWORK (GNSS) UTILIZING THE UTM 12S NETWORK TO GO FROM STATE PLANE COORDINATES TO GROUND COORDINATES MULTIPLY BY 1.0002.

BASIS OF ELEVATIONS (NOT SHOWN IN PLAN)

REFERENCE BENCHMARK (NGS PID: AA9458) STATION IS LOCATED ABOUT 3.1 MILES NORTH OF MINDEN, NV, 1.25 MILES EAST OF US HIGHWAY 394. AT THE DOUGLAS COUNTY AIRPORT ON THE EAST SIDE OF THE SYMMETRICAL RUNWAY 16-34 IN A GRASSY AREA.

ELEVATION= 4704.67' DATUM= NAVD83 - GECID 128

SITE BENCHMARK

SET COTTON SPINDLE - CONTROL POINT COTTON


ELEVATION= 4867.28' DATUM= NAVD83 - GECID 128

OWNER

DOUGLAS COUNTY, NV
1000 W. 10TH ST., 2ND FLOOR
MINDEN, NV 89423
CONTACT: NICK CHARLES
PHONE: 775.783.6437

CIVIL ENGINEER

KELLER ASSOCIATES, INC.
1325 ARMOTIVE WAY, SUITE 375
RENO, NV 89502
CONTACT: ERIK WILSON, PE
PHONE: 775.451.7288

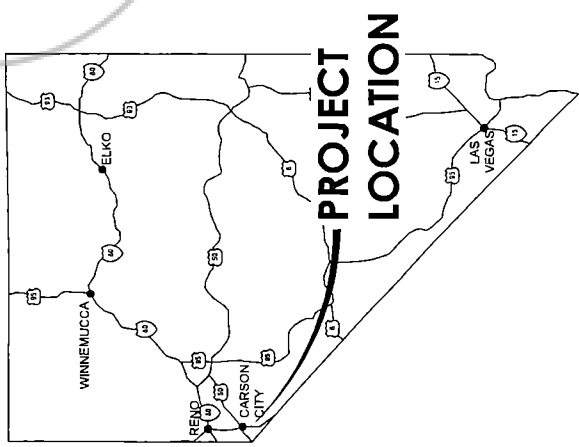

A1 LOCATION MAP
N.T.S.

A3 VICINITY MAP
N.T.S.



Know what's below.
Call before you dig.
68462

DISCIPLINE DESIGNATORS

- G GENERAL DRAWINGS
- S SURVEY DRAWINGS
- C CIVIL DRAWINGS
- A ARCHITECTURAL DRAWINGS
- STR STRUCTURAL DRAWINGS
- M MECHANICAL DRAWINGS
- MH HVAC DRAWINGS
- M MECHANICAL PROCESS DRAWINGS
- E ELECTRICAL DRAWINGS
- EI ELECTRICAL INSTRUMENTATION DRAWINGS

CIVIL SHEET TYPES

- 0XX GENERAL (SYMBOLS, LEGEND, NOTES, TOPOGRAPHY, ETC.)
- 1XX EXISTING SITE AND ACCESS
- 2XX SITE DEMOLITION PLAN
- 4XX UTILITY (PLAN VIEW, PLAN & PROFILES, ETC.)
- 5XX PROJECT DETAILS
- 8XX MISCELLANEOUS

STRUCTURE SHEET TYPES


- 0XX GENERAL (SYMBOLS, LEGEND, NOTES, ETC.)
- 1XX FOUNDATION DETAILS
- 2XX ELEVATIONS (VERTICAL VIEWS)
- 3XX SECTIONS (SECTION VIEWS)
- 4XX LARGE SCALE VIEWS (PLANS, ELEVATIONS OR SECTIONS)
- 5XX PROJECT DETAILS
- 8XX SPECIAL DETAILS
- 7XX USER DEFINED (FOR TYPES WHICH DO NOT FALL IN OTHER CATEGORIES)

SHEET NUMBERING KEY

DISCIPLINE DESIGNATOR M - 101 - C
 SHEET TYPE


DETAIL & SECTION CALLOUT KEY

(REFERENCE)
 RE: A1/S-101-A (PROJECT DETAIL NO./SHEET NO.)
 RE: S120 (STANDARD DETAIL NO.)

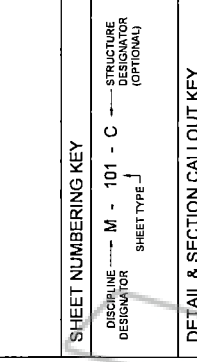

LIST OF DRAWINGS

SHEET LIST TABLE	
SHEET NUMBER	SHEET TITLE
GENERAL	
G-001	TITLE SHEET
G-002	SHEET INDEX
G-003	NOTES SHEET
G-004	STANDARD ABBREVIATIONS
G-005	STANDARD ABBREVIATIONS CONT.
G-006	PIPE SCHEDULE
CIVIL	
C-001	SYMBOLS & LINE LEGEND
C-010	EXISTING SITE AND ACCESS
C-020	SITE DEMOLITION PLAN
C-100	SITE PLAN KEY MAP
C-110	WATER TANKS SITE PLAN
C-200	GRADING KEY MAP
C-201	GRADING NEW PLAN
C-210	WATER TANKS GRADING PLAN
C-211	GENERAL PROJECT CROSS SECTION
C-311	TANK 1 CROSS SECTION
C-312	TANK 2 CROSS SECTION
C-314	ENERGY DESCRIPTION SECTION
C-400	YARD PRINC KEY MAP
C-410	WATER LINE PLAN & PROFILE
C-411	RAIN LINE PLAN & PROFILE
C-412	STORMWATER CULVERT PLAN & PROFILE
C-501	VAULT DETAILS
C-510	CIVIL DETAILS
C-511	DOUGLAS COUNTY DETAILS (1 OF 3)
C-512	DOUGLAS COUNTY DETAILS (2 OF 3)
C-513	DOUGLAS COUNTY DETAILS (3 OF 3)
SITE ELECTRICAL	
E-120	ELECTRICAL SITE PLAN
TANK 1	
S-101	TANK 1 - STRUCTURAL PLAN
S-301	TANK 1 - MECHANICAL PLAN
M-101	TANK 1 - ELECTRICAL AND INSTRUMENTATION PLAN
E-101	TANK 1 - ELECTRICAL AND INSTRUMENTATION PLAN
TANK 2	
S-102	TANK 2 - STRUCTURAL PLAN
S-302	TANK 2 - STRUCTURAL SECTION
M-102	TANK 2 - MECHANICAL PLAN
E-102	TANK 2 - MECHANICAL PLAN
STRUCTURAL DETAILS TANKS 1 & 2	
S-501	STRUCTURAL DETAILS
S-502	STRUCTURAL DETAILS
S-503	STRUCTURAL DETAILS
S-504	STRUCTURAL DETAILS
ELECTRICAL	
E-501	ELECTRICAL DETAILS
E-601	ONE-LINE DIAGRAM
E-602	CABLE AND CONDUIT SCHEDULES
EI-001	PAID LEGEND
EI-002	PAID LEGEND
EI-003	PAID LEGEND
EI-701	PAID

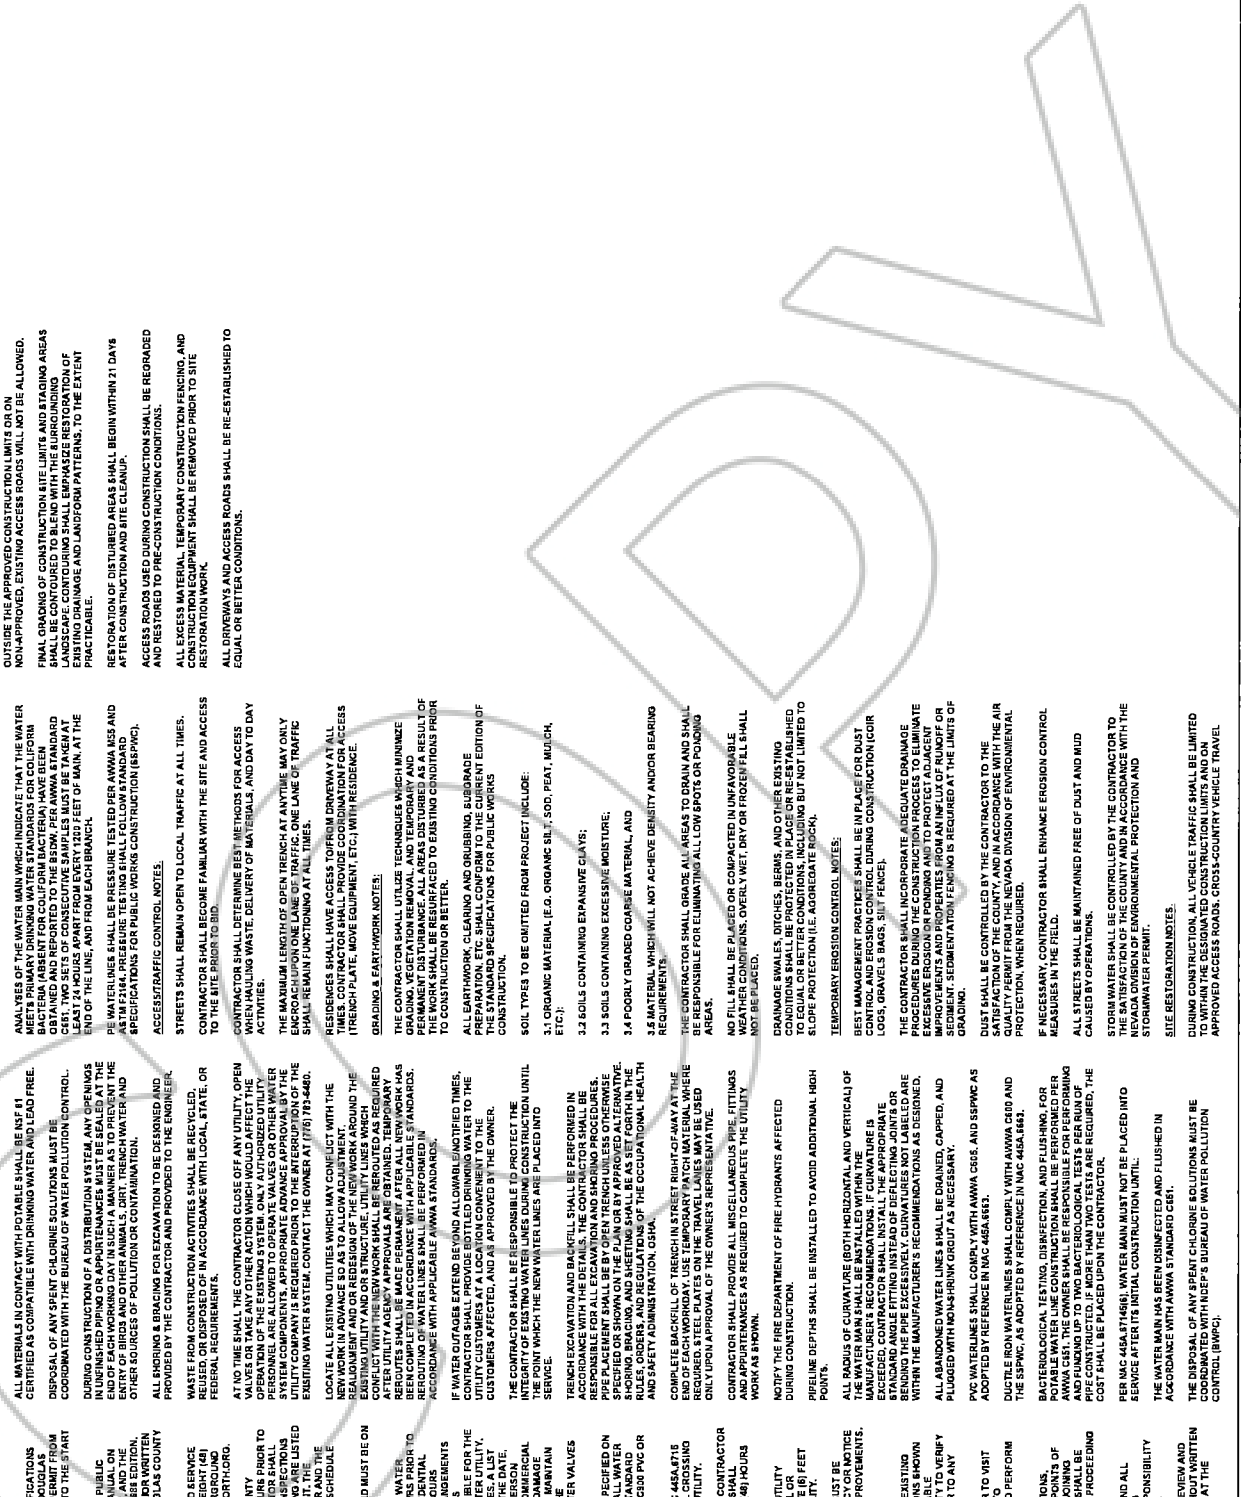

DOUGLAS COUNTY GENERAL WATER UTILITY NOTES:
 ALL WORK SHALL CONFORM TO THE STANDARD SPECIFICATIONS FOR PUBLIC WORKS CONSTRUCTION AS ADOPTED BY DOUGLAS COUNTY. THE STANDARD SPECIFICATIONS SHALL BE THE DOUGLAS COUNTY COMMUNITY DEVELOPMENT PRIOR TO THE START OF CONSTRUCTION.

ALL TRAFFIC CONTROL AND BARRICADE WITHIN THE PUBLIC RIGHT-OF-WAY SHALL CONFORM TO PART OF THE MANUAL ON UNIFORM TRAFFIC CONTROL DEVICES, LATEST EDITION, AND THE STANDARD SPECIFICATIONS FOR PUBLIC WORKS CONSTRUCTION. NO STREET CLOSURES WILL BE ALLOWED WITHOUT PRIOR WRITTEN APPROVAL OF A TRAFFIC CONTROL PLAN BY THE DOUGLAS COUNTY ENGINEERING DIVISION.

THE OWNER/CONTRACTOR SHALL CALL UNDERGROUND SERVICE ALERT "CALL BEFORE YOU DIG" 48 HOURS PRIOR TO THE START OF CONSTRUCTION. THE OWNER/CONTRACTOR SHALL CALL 24 HOURS PRIOR TO THE START OF CONSTRUCTION. THE OWNER/CONTRACTOR SHALL CALL 24 HOURS PRIOR TO THE START OF CONSTRUCTION. THE OWNER/CONTRACTOR SHALL CALL 24 HOURS PRIOR TO THE START OF CONSTRUCTION.

THE APPROVED PLAN, PERMIT AND INSPECTION RECORD MUST BE ON THE JOB SITE AT ALL TIMES.
 WATER MAIN SHUTDOWNS/INTERRUPTION OF SERVICE: WATER UTILITY APPROVAL IS REQUIRED FORTY-EIGHT (48) HOURS PRIOR TO THE START OF CONSTRUCTION. THE OWNER/CONTRACTOR SHALL NOTIFY THE WATER UTILITY AS EARLY AS POSSIBLE. THE WATER UTILITY CUSTOMERS SHALL BOTH RECEIVE FORTY-EIGHT (48) HOURS WRITTEN NOTICE OF A SHUTDOWN, AND SPECIAL ARRANGEMENTS MUST BE MADE TO ACCOMMODATE CUSTOMERS. CUSTOMERS TO BE AFFECTED BY A SHUTDOWN SHALL BE NOTIFIED BY THE WATER UTILITY THROUGH THE COMMERCIAL CUSTOMER SERVICE CENTER. THE CONTRACTOR SHALL BE RESPONSIBLE FOR THE TIME AND ADDRESS OF ALL PERSONS NOTIFIED. THE PERSON(S) NOTIFIED SHALL BE INCLUDED ON THE LIST FOR ALL COMMERCIAL CUSTOMERS. THE CONTRACTOR WILL BE SUBJECT TO DAMAGE TO PROPERTY AND LITIGATION IF CUSTOMERS ARE NOT NOTIFIED OF THE INTERRUPTION OF SERVICE IN ACCORDANCE WITH THE WATER UTILITY POLICY.

WATER VALVE MARKERS SHALL BE BLUE CARBONITE UTILITY MARKERS AS SPECIFIED ON THE STANDARD SPECIFICATIONS FOR PUBLIC WORKS CONSTRUCTION. APPROVED EQUAL OR GREATER SHALL BE ACCEPTED. WATER VALVE MARKERS SHALL BE PLACED AT LEAST FIVE (5) FEET FROM THE VALVE OR AS DIRECTED BY THE WATER UTILITY.

ALL WATER MAIN AND WATER SERVICE INSPECTIONS MUST BE COMPLETED PRIOR TO ANY CERTIFICATE OF OCCUPANCY OR NOTICE OF COMPLETION BY THE WATER UTILITY ACCEPTING IMPROVEMENTS.
WATER NOTES:
 DOUGLAS COUNTY ASSUMES NO RESPONSIBILITY FOR EXISTING CONNECTIONS WITH EXISTING IMPROVEMENTS AND ADJOINING PROPERTY. THE CONTRACTOR'S RESPONSIBILITY TO VERIFY EXISTING MAIN AND ELEVATIONS OF ALL UTILITIES PRIOR TO ANY CONSTRUCTION.
 IT SHALL BE THE RESPONSIBILITY OF THE CONTRACTOR TO VISIT THE JOB SITE TO VERIFY THE LOCATION, DEPTH, AND MATERIALS, METHODS, AND EQUIPMENT NECESSARY TO PERFORM THE WORK REQUIRED FOR THIS PROJECT.
 THE CONTRACTOR SHALL VERIFY IN FIELD, ALL ELEVATIONS DIMENSIONS, FLOW LINES, EXISTING CONDITIONS, AND POINTS OF CONNECTIONS WITH EXISTING IMPROVEMENTS AND ADJOINING PROPERTY. THE CONTRACTOR SHALL VERIFY THE EXISTING MAIN AND ELEVATIONS ARE CORRECT. THE CONTRACTOR SHALL BE CALLED TO THE ATTENTION OF THE ENGINEER BEFORE PROCEEDING WITH THE WORK.

THE CONTRACTOR SHALL BE RESPONSIBLE FOR ANY AND ALL DAMAGE TO EXISTING UTILITIES ENCOUNTERED DURING CONSTRUCTION. IT SHALL BE THE CONTRACTOR'S RESPONSIBILITY TO CONTACT THE UTILITY COMPANIES FOR LOCATIONS. MODIFICATIONS TO THE APPROVED PLANS REQUIRES REVIEW AND APPROVAL BY THE ENGINEER. WORK PERFORMED WITHOUT WRITTEN APPROVAL OF THE ENGINEER WILL REQUIRE REMOVAL AT THE CONTRACTOR'S EXPENSE.

ANALYSES OF THE WATER MAIN WHICH INDICATE THAT THE WATER BACTERIA (ABSENT FOR COLIFORM BACTERIA) HAVE BEEN IDENTIFIED. TWO SETS OF CONSECUTIVE SAMPLES MUST BE TAKEN AT LEAST 24 HOURS APART FROM EVERY 1200 FEET OF MAIN, AT THE END OF THE LINE, AND FROM EACH BRANCH.
 WATER UTILITY SHALL BE PRESSURE TESTED PER AWWA 655 AND AWWA C200. PRELIMINARY TESTING SHALL FOLLOW STANDARD SPECIFICATIONS FOR PUBLIC WORKS CONSTRUCTION (SP-PMO).
 ACCESS/TRAFFIC CONTROL NOTES:
 STREETS SHALL REMAIN OPEN TO LOCAL TRAFFIC AT ALL TIMES. CONTRACTOR SHALL BECOME FAMILIAR WITH THE SITE AND ACCESS TO THE SITE PRIOR TO BID.
 CONTRACTOR SHALL DETERMINE BEST METHODS FOR ACCESS WHEN HAULING WASTE, DELIVERY OF MATERIALS, AND DAY TO DAY ACTIVITIES.
 THE MAXIMUM LENGTH OF OPEN TRENCH AT ANYTIME MAY ONLY BE 100 FEET. ALL TRENCHES SHALL BE PROTECTED AT ALL TIMES. SHIELDING SHALL REMAIN FUNCTIONING AT ALL TIMES.

RESIDENCES SHALL HAVE ACCESS TO FORM DRIVEWAY AT ALL TIMES. THE CONTRACTOR SHALL MAINTAIN ACCESS TO ALL EXISTING UTILITY TRENCH PLATE, MOVE EQUIPMENT, ETC.) WITH RESIDENCE.
GRADING & EARTHWORK NOTES:
 THE CONTRACTOR SHALL UTILIZE TECHNIQUES WHICH MINIMIZE GRADING, VEGETATION REMOVAL, AND TEMPORARY AND PERMANENT EROSION CONTROL MEASURES. THE RESULTS OF THE WORK SHALL BE PRESERVED TO EXISTING CONDITIONS PRIOR TO CONSTRUCTION OR BETTER.
 ALL EARTHWORK, CLEARING AND ORBUSSING, SUBGRADE PREPARATION, ETC. SHALL CONFORM TO THE CURRENT EDITION OF THE STANDARD SPECIFICATIONS FOR PUBLIC WORKS CONSTRUCTION.

SOIL TYPES TO BE OBTAINED FROM PROJECT INCLUDE:
 3.1 ORGANIC MATERIAL (E.G. ORGANIC SILT, SOD, PEAT, MUD, ETC.);
 3.2 SOILS CONTAINING EXPANSIVE CLAYS;
 3.3 SOILS CONTAINING EXCESSIVE MOISTURE;
 3.4 POORLY GRADED COARSE MATERIAL, AND
 3.6 MATERIAL WHICH WILL NOT ACHIEVE DENSITY AND/OR BEARING REQUIREMENTS.
 THE CONTRACTOR SHALL GRADE ALL AREAS TO DRAIN AND SHALL BE RESPONSIBLE FOR ELIMINATING ALL LOW SPOTS OR POUNDING AREAS.
 NO FILL SHALL BE PLACED OR COMPACTED IN UNFAVORABLE WEATHER CONDITIONS, OVERLY WET, DRY OR FROZEN FILL SHALL NOT BE USED.

TEMPORARY EROSION CONTROL NOTES:
 BEST MANAGEMENT PRACTICES SHALL BE IN PLACE FOR DUST AND EROSION CONTROL DURING CONSTRUCTION (DIRT LOGS, GRAVEL BAGS, SILT FENCE).
 THE CONTRACTOR SHALL INCORPORATE ADEQUATE DRAINAGE IMPROVEMENTS AND PROPERTIES FROM AN INFLUX OF RUNOFF OR EXCESSIVE EROSION OR PONDING AND TO PROTECT ADJACENT PROPERTY. SEDIMENTATION TRENCHING IS REQUIRED AT THE LIMITS OF GRADING.
 DUST SHALL BE CONTROLLED BY THE CONTRACTOR TO THE EXTENT POSSIBLE. THE CONTRACTOR SHALL MAINTAIN AIR QUALITY PERMIT FROM THE NEVADA DIVISION OF ENVIRONMENTAL PROTECTION, WHEN REQUIRED.
 IF NECESSARY CONTRACTOR SHALL ENHANCE EROSION CONTROL MEASURES IN THE FIELD.
 ALL STREETS SHALL BE MAINTAINED FREE OF DUST AND MUD CAUSED BY OPERATIONS.
 STOP WATER SHALL BE CONTROLLED BY THE CONTRACTOR TO THE EXTENT POSSIBLE. THE CONTRACTOR SHALL MAINTAIN THE NEVADA DIVISION OF ENVIRONMENTAL PROTECTION AND STOP WATER PERMIT.

SITE RESTORATION NOTES:
 DURING CONSTRUCTION ALL VEHICLE TRAFFIC SHALL BE LIMITED TO APPROVED ACCESS ROADS. CROSS-COUNTRY VEHICLE TRAVEL SHALL BE PROHIBITED.

NOTIFY THE FIRE DEPARTMENT OF FIRE HYDRANTS AFFECTED DURING CONSTRUCTION.
 PIPELINE DEPTHS SHALL BE INSTALLED TO AVOID ADDITIONAL HIGH POINTS.
 ALL RADIUS OF CURVATURE (BOTH HORIZONTAL AND VERTICAL) OF THE WATER MAIN SHALL BE INSTALLED WITHIN THE TOLERANCES EXCEEDED. CONTRACTOR SHALL INSTALL THE APPROPRIATE STANDARD ANGLE FITTING INSTEAD OF DEFLECTING JOINTS OR BENDS. THE CONTRACTOR SHALL VERIFY THE FITTINGS ARE WITHIN THE MANUFACTURER'S RECOMMENDATIONS AS DISCLOSED.
 ALL ABANDONED WATER LINES SHALL BE DRAINED, CAPPED, AND PLUGGED WITH MONS-HOOK (HOUT) AS NECESSARY.
 PVC WATER LINES SHALL COMPLY WITH AWWA C900, AND SSPWC AS ADOPTED BY REFERENCE IN MAC 468A 6653.
 DUCTILE IRON WATER LINES SHALL COMPLY WITH AWWA C900 AND THE SPWC, AS ADOPTED BY REFERENCE IN MAC 468A 6664.

BACTERIOLOGICAL TESTING, DISINFECTION, AND FLUSHING FOR POTABLE WATER LINE CONSTRUCTION SHALL BE PERFORMED PER AWWA C917. THE OWNER SHALL BE RESPONSIBLE FOR PERFORMING ALL TESTING AND FLUSHING. MORE THAN TWO TESTS ARE REQUIRED. THE COST SHALL BE PLACED UPON THE CONTRACTOR.
 PER MAC 468A 674863, WATER MAIN MUST NOT BE PLACED INTO SERVICE AFTER ITS INITIAL CONSTRUCTION UNTIL:
 THE WATER MAIN HAS BEEN DISINFECTED AND FLUSHED IN ACCORDANCE WITH AWWA STANDARD C900.
 THE DISPOSAL OF ANY SPEN CHLORINE SOLUTIONS MUST BE CONTROLLED BY THE BUREAU OF WATER POLLUTION CONTROL (BWP/C).

ALL MATERIALS IN CONTACT WITH POTABLE WATER SHALL BE NSF IF CERTIFIED AS COMPATIBLE WITH DRINKING WATER AND LEAD FREE. DISPOSAL OF ANY SPEN CHLORINE SOLUTIONS MUST BE IN ACCORDANCE WITH THE BUREAU OF WATER POLLUTION CONTROL.

NOISE CONTROL: CONSTRUCTION NOISE SHALL BE MINIMIZED BY USING QUIET EQUIPMENT. THE CONTRACTOR SHALL TAKE ALL NECESSARY MEASURES TO PREVENT THE ENTRY OF BIRDS AND OTHER ANIMALS, DRIP, TRENCH WATER AND OTHER SOURCES OF POLLUTION OR CONTAMINATION.
 ALL SHORING & BRACING FOR EXCAVATION TO BE DESIGNED AND PROVIDED BY THE CONTRACTOR AND PROVIDED TO THE ENGINEER FOR REVIEW AND APPROVAL.
 WASTE FROM CONSTRUCTION ACTIVITIES SHALL BE RECYCLED, REUSED, OR DISPOSED OF IN ACCORDANCE WITH LOCAL, STATE, OR FEDERAL REQUIREMENTS.

AT NO TIME SHALL THE CONTRACTOR CLOSE OFF ANY UTILITY, OPEN VALVES OR TAKE ANY OTHER ACTION WHICH WOULD AFFECT THE SYSTEM COMPONENTS. APPROPRIATE ADVANCE APPROVAL BY THE ENGINEER SHALL BE OBTAINED PRIOR TO CLOSING OFF ANY UTILITY.
 LOCATE ALL EXISTING UTILITIES WHICH MAY CONFLICT WITH THE PROPOSED TRENCHING AND/OR REVISIONS OF THE NEW WORK AROUND THE EXISTING UTILITY AND/OR STRUCTURE. UTILITY LINES WHICH CONFLICT WITH THE PROPOSED TRENCHING SHALL BE RECORDED AND MARKED. THE CONTRACTOR SHALL BE RESPONSIBLE FOR OBTAINING NECESSARY PERMITS AND RECORDS IN ACCORDANCE WITH APPLICABLE STANDARDS.
 IF WATER OUTGAS EXTENDS BEYOND ALLOWABLE (UNSPECIFIED) TIME, THE CONTRACTOR SHALL BE RESPONSIBLE TO PROTECT THE UTILITY CUSTOMERS AT A LOCATION CONVENIENT TO THE CUSTOMERS AFFECTED, AND AS APPROVED BY THE OWNER.
 THE CONTRACTOR SHALL BE RESPONSIBLE TO PROTECT THE INTEGRITY OF EXISTING WATER LINES DURING CONSTRUCTION UNTIL THE POINT WHICH THE NEW WATER LINES ARE PLACED INTO SERVICE.

TRENCH EXCAVATION AND BACKFILL SHALL BE PERFORMED IN ACCORDANCE WITH THE STANDARD SPECIFICATIONS FOR PUBLIC WORKS CONSTRUCTION. ALL EXCAVATION AND SHORING PROCEDURES, PIPE PLACEMENT SHALL BE BY OPEN TRENCH UNLESS OTHERWISE SPECIFIED OR SHOWN ON THE PLAN OR BY APPROVED ALTERNATIVE. THE CONTRACTOR SHALL COMPLY WITH ALL LOCAL, STATE, FEDERAL, RULES, ORDERS, AND REGULATIONS OF THE OCCUPATIONAL HEALTH AND SAFETY ADMINISTRATION, OSHA.
 COMPLETE BACKFILL OF TRENCH STREET RIGHT-OF-WAY AT THE END OF EACH WORKDAY. USE TEMPORARY PATCH MATERIAL WHERE REQUIRED. STEEL PLATES ON TRAVEL LANES MAY BE USED ONLY UPON APPROVAL OF THE OWNER'S REPRESENTATIVE.
 CONTRACTOR SHALL PROVIDE ALL MISCELLANEOUS PIPE, FITTINGS AND APPURTENANCES AS REQUIRED TO COMPLETE THE UTILITY WORK AS SHOWN.

ALL RADIUS OF CURVATURE (BOTH HORIZONTAL AND VERTICAL) OF THE WATER MAIN SHALL BE INSTALLED WITHIN THE TOLERANCES EXCEEDED. CONTRACTOR SHALL INSTALL THE APPROPRIATE STANDARD ANGLE FITTING INSTEAD OF DEFLECTING JOINTS OR BENDS. THE CONTRACTOR SHALL VERIFY THE FITTINGS ARE WITHIN THE MANUFACTURER'S RECOMMENDATIONS AS DISCLOSED.
 ALL ABANDONED WATER LINES SHALL BE DRAINED, CAPPED, AND PLUGGED WITH MONS-HOOK (HOUT) AS NECESSARY.
 PVC WATER LINES SHALL COMPLY WITH AWWA C900, AND SSPWC AS ADOPTED BY REFERENCE IN MAC 468A 6653.
 DUCTILE IRON WATER LINES SHALL COMPLY WITH AWWA C900 AND THE SPWC, AS ADOPTED BY REFERENCE IN MAC 468A 6664.

BACTERIOLOGICAL TESTING, DISINFECTION, AND FLUSHING FOR POTABLE WATER LINE CONSTRUCTION SHALL BE PERFORMED PER AWWA C917. THE OWNER SHALL BE RESPONSIBLE FOR PERFORMING ALL TESTING AND FLUSHING. MORE THAN TWO TESTS ARE REQUIRED. THE COST SHALL BE PLACED UPON THE CONTRACTOR.
 PER MAC 468A 674863, WATER MAIN MUST NOT BE PLACED INTO SERVICE AFTER ITS INITIAL CONSTRUCTION UNTIL:
 THE WATER MAIN HAS BEEN DISINFECTED AND FLUSHED IN ACCORDANCE WITH AWWA STANDARD C900.
 THE DISPOSAL OF ANY SPEN CHLORINE SOLUTIONS MUST BE CONTROLLED BY THE BUREAU OF WATER POLLUTION CONTROL (BWP/C).

NOTIFY THE FIRE DEPARTMENT OF FIRE HYDRANTS AFFECTED DURING CONSTRUCTION.
 PIPELINE DEPTHS SHALL BE INSTALLED TO AVOID ADDITIONAL HIGH POINTS.
 ALL RADIUS OF CURVATURE (BOTH HORIZONTAL AND VERTICAL) OF THE WATER MAIN SHALL BE INSTALLED WITHIN THE TOLERANCES EXCEEDED. CONTRACTOR SHALL INSTALL THE APPROPRIATE STANDARD ANGLE FITTING INSTEAD OF DEFLECTING JOINTS OR BENDS. THE CONTRACTOR SHALL VERIFY THE FITTINGS ARE WITHIN THE MANUFACTURER'S RECOMMENDATIONS AS DISCLOSED.
 ALL ABANDONED WATER LINES SHALL BE DRAINED, CAPPED, AND PLUGGED WITH MONS-HOOK (HOUT) AS NECESSARY.
 PVC WATER LINES SHALL COMPLY WITH AWWA C900, AND SSPWC AS ADOPTED BY REFERENCE IN MAC 468A 6653.
 DUCTILE IRON WATER LINES SHALL COMPLY WITH AWWA C900 AND THE SPWC, AS ADOPTED BY REFERENCE IN MAC 468A 6664.

ALL TRAFFIC CONTROL AND BARRICADE WITHIN THE PUBLIC RIGHT-OF-WAY SHALL CONFORM TO PART OF THE MANUAL ON UNIFORM TRAFFIC CONTROL DEVICES, LATEST EDITION, AND THE STANDARD SPECIFICATIONS FOR PUBLIC WORKS CONSTRUCTION. NO STREET CLOSURES WILL BE ALLOWED WITHOUT PRIOR WRITTEN APPROVAL OF A TRAFFIC CONTROL PLAN BY THE DOUGLAS COUNTY ENGINEERING DIVISION.

THE OWNER/CONTRACTOR SHALL CALL UNDERGROUND SERVICE ALERT "CALL BEFORE YOU DIG" 48 HOURS PRIOR TO THE START OF CONSTRUCTION. THE OWNER/CONTRACTOR SHALL CALL 24 HOURS PRIOR TO THE START OF CONSTRUCTION. THE OWNER/CONTRACTOR SHALL CALL 24 HOURS PRIOR TO THE START OF CONSTRUCTION.

THE APPROVED PLAN, PERMIT AND INSPECTION RECORD MUST BE ON THE JOB SITE AT ALL TIMES.
 WATER MAIN SHUTDOWNS/INTERRUPTION OF SERVICE: WATER UTILITY APPROVAL IS REQUIRED FORTY-EIGHT (48) HOURS PRIOR TO THE START OF CONSTRUCTION. THE OWNER/CONTRACTOR SHALL NOTIFY THE WATER UTILITY AS EARLY AS POSSIBLE. THE WATER UTILITY CUSTOMERS SHALL BOTH RECEIVE FORTY-EIGHT (48) HOURS WRITTEN NOTICE OF A SHUTDOWN, AND SPECIAL ARRANGEMENTS MUST BE MADE TO ACCOMMODATE CUSTOMERS. CUSTOMERS TO BE AFFECTED BY A SHUTDOWN SHALL BE NOTIFIED BY THE WATER UTILITY THROUGH THE COMMERCIAL CUSTOMER SERVICE CENTER. THE CONTRACTOR SHALL BE RESPONSIBLE FOR THE TIME AND ADDRESS OF ALL PERSONS NOTIFIED. THE PERSON(S) NOTIFIED SHALL BE INCLUDED ON THE LIST FOR ALL COMMERCIAL CUSTOMERS. THE CONTRACTOR WILL BE SUBJECT TO DAMAGE TO PROPERTY AND LITIGATION IF CUSTOMERS ARE NOT NOTIFIED OF THE INTERRUPTION OF SERVICE IN ACCORDANCE WITH THE WATER UTILITY POLICY.

WATER VALVE MARKERS SHALL BE BLUE CARBONITE UTILITY MARKERS AS SPECIFIED ON THE STANDARD SPECIFICATIONS FOR PUBLIC WORKS CONSTRUCTION. APPROVED EQUAL OR GREATER SHALL BE ACCEPTED. WATER VALVE MARKERS SHALL BE PLACED AT LEAST FIVE (5) FEET FROM THE VALVE OR AS DIRECTED BY THE WATER UTILITY.

ALL WATER MAIN AND WATER SERVICE INSPECTIONS MUST BE COMPLETED PRIOR TO ANY CERTIFICATE OF OCCUPANCY OR NOTICE OF COMPLETION BY THE WATER UTILITY ACCEPTING IMPROVEMENTS.
WATER NOTES:
 DOUGLAS COUNTY ASSUMES NO RESPONSIBILITY FOR EXISTING CONNECTIONS WITH EXISTING IMPROVEMENTS AND ADJOINING PROPERTY. THE CONTRACTOR'S RESPONSIBILITY TO VERIFY EXISTING MAIN AND ELEVATIONS OF ALL UTILITIES PRIOR TO ANY CONSTRUCTION.

IT SHALL BE THE RESPONSIBILITY OF THE CONTRACTOR TO VISIT THE JOB SITE TO VERIFY THE LOCATION, DEPTH, AND MATERIALS, METHODS, AND EQUIPMENT NECESSARY TO PERFORM THE WORK REQUIRED FOR THIS PROJECT.
 THE CONTRACTOR SHALL VERIFY IN FIELD, ALL ELEVATIONS DIMENSIONS, FLOW LINES, EXISTING CONDITIONS, AND POINTS OF CONNECTIONS WITH EXISTING IMPROVEMENTS AND ADJOINING PROPERTY. THE CONTRACTOR SHALL VERIFY THE EXISTING MAIN AND ELEVATIONS ARE CORRECT. THE CONTRACTOR SHALL BE CALLED TO THE ATTENTION OF THE ENGINEER BEFORE PROCEEDING WITH THE WORK.

THE CONTRACTOR SHALL BE RESPONSIBLE FOR ANY AND ALL DAMAGE TO EXISTING UTILITIES ENCOUNTERED DURING CONSTRUCTION. IT SHALL BE THE CONTRACTOR'S RESPONSIBILITY TO CONTACT THE UTILITY COMPANIES FOR LOCATIONS. MODIFICATIONS TO THE APPROVED PLANS REQUIRES REVIEW AND APPROVAL BY THE ENGINEER. WORK PERFORMED WITHOUT WRITTEN APPROVAL OF THE ENGINEER WILL REQUIRE REMOVAL AT THE CONTRACTOR'S EXPENSE.



5/1 Design:
 Rev: 01
 Nuel For
 Construction

NO. REVISIONS
 DATE
 THIS SHEET IS PART OF THE PROJECT AND IS NOT TO BE REPRODUCED OR COPIED IN ANY MANNER WITHOUT THE WRITTEN PERMISSION OF KELLER ASSOCIATES INC.



MOUNTAIN VIEW WATER TANK
 REPLACEMENT
 PIPE SCHEDULE

DRAWN: JH/DECK, JAV
 VERIFY SCALE. SOUNDS
 based on 22"x34" prints.
 PROJECT NO: 223125
 SHEET NO: G-006

- GENERAL SHEET NOTES**
- FOR FIELD TEST PROCEDURES AND ADDITIONAL TEST REQUIREMENTS, SEE PIPING SECTION OF SPECIFICATIONS.
 - FOR ACCEPTABLE PIPE USAGES, SEE PIPING SECTION OF SPECIFICATIONS.
 - FOR PIPE FITTINGS, SEE PIPING SECTION OF SPECIFICATIONS.
 - EXPOSED PIPING SHALL BE PAINTED IN ACCORDANCE WITH SPECIFICATIONS. COLORS SHALL BE SELECTED BY OWNER.
 - EXPOSED PIPING SHALL BE INSULATED WHERE SHOWN. SEE SPECIFICATIONS FOR INSULATION REQUIREMENTS.
 - DUCTILE IRON PIPE, POLYETHYLENE GLEUVE REQUIRED WHERE BURIED.
 - ANY DEVIATION FROM THE PIPING MATERIALS OR FIELD TEST PROCEDURES WILL BE NOTED IN THE SPECIFICATIONS OR ON THE DRAWINGS.

PIPE MATERIAL SCHEDULE		PIPE MATERIALS	
ABBREVIATION	SERVICE	MATERIAL	DETAILS
W	WATER (POTABLE)	POLYVINYL CHLORIDE (PVC)	ASTM D2241, SDR 35
DR	DRAIN	POLYVINYL CHLORIDE (PVC)	AWWA C200
SD	STORM DRAIN	STAINLESS STEEL	ASTM A312, 304L, SEAMLESS; SCHEDULE 10S, WELDED
V	VENT	STEEL	AWWA C200, 3/16-INCH THICK, LINED

PIPE TESTING SCHEDULE			
ID	SPECIFICATION	TEST MEDIUM	TEST PRESSURE - (PSI)
C	33.01.12	WATER	150
			LEAKAGE ALLOWANCE
			0



90 Design
 Review
 Not for
 Construction

NO. _____
 DATE _____
 REVISIONS
 1. _____
 2. _____
 3. _____
 100. _____



**MOUNTAIN VIEW WATER TANK
 REPLACEMENT
 SYMBOLS & LINE LEGEND**

DRAWN BY: JACHECK JW
 VERIFY SCALE: Scales based on 22'x34" prints, 1" = 10' (includes 1/2" blank)
 PROJECT NO: 223125
 SHEET NO: C-001

EXISTING TOPOGRAPHY

- TOPOGRAPHIC CONTOUR
- EDGE OF GRAVEL
- EDGE OF PAVEMENT
- CURB & GUTTER, SIDEWALK & DROP INLET
- FENCE (BARBED WIRE OR OTHER WITH GATES)
- FENCE (CHAINLINK WITH GATE)
- DITCH FLOWLINE
- TEST PIT
- SIGN
- BUILDING OR STRUCTURE

PROPERTY & CONTROL

- SURVEY CONTROL POINT
- BENCHMARK
- FOUND BRASS CAP
- FOUND ALUMINUM CAP
- FOUND 5" STEEL PIN
- FOUND 5/8" STEEL PIN W/CAP
- FOUND 1/2" STEEL PIN
- SET 1/2" 6" STEEL PIN W/CAP
- FOUND PK NAIL
- SET PK NAIL
- CALCULATED POINT
- WITNESS CORNER
- EASEMENT - UTILITY
- EASEMENT - TEMPORARY
- EASEMENT - SETBACK
- PROJECT BOUNDARY
- PROPERTY LINES

EXISTING UTILITY

- WATERLINE & VALVE
- SANITARY SEWER LINE & MANHOLE
- PRESSURE SEWER SERVICE & CLEANOUT
- PRESSURE SEWER LINE & VALVE VAULT
- STORM DRAIN LINE & MANHOLE
- PRESSURE IRRIGATION & VALVE
- GRAVITY IRRIGATION & MANHOLE
- OVERHEAD POWER LINE & POWER POLE
- UNDERGROUND POWER LINE
- SIGNAL POLE
- LIGHT POLE
- NATURAL GAS LINE
- FIBER OPTIC LINE
- TELEPHONE LINE & RISER
- CABLE LINE & RISER

PROPOSED GRADING

- TOPOGRAPHIC CONTOUR
- RIDGELINE
- DRAINAGE ARROW & SLOPE
- SPOT ELEVATION
- SWALE FLOWLINE
- DAYLIGHT - CUT LINE
- DAYLIGHT - FILL LINE

PROPOSED DEMOLITION, ABANDONMENT, REMOVAL

- DEMOLITION & REMOVAL
- ABANDON IN PLACE
- REMOVE SURFACE FEATURE
- CLEARING AND GRUBBING

PROPOSED SITE

- BUILDING OR STRUCTURE
- CONCRETE
- ASPHALT
- GRAVEL SURFACE
- GRAVEL SECTION
- LANDSCAPE ROCK

PROPOSED SITE (CONT.)


- GENERIC GATE
- SLIDER GATE
- EDGE OF PAVEMENT
- EDGE OF GRAVEL
- SIGN
- VERTICAL CURB, GUTTER, SIDEWALK & INLET
- REVERSE CURB & GUTTER
- REVERSE CUT CURB & GUTTER
- IMBEDDED CURB

PROPOSED UTILITY

- MECHANICAL JOINT
- BEND
- REDUCING TEE
- TEE
- REDUCER
- FLANGE TO MECHANICAL JOINT COUPLING
- CROSS
- CAP W/BLIND FLANGE
- CHECK VALVE
- GATE VALVE
- BUTTERFLY VALVE
- BLOWOFF VALVE
- RESTRAINED FITTING
- WATER SERVICE LINE & METER
- FIRE HYDRANT
- FIRE LINE
- WATERLINE
- MONITORING WELL
- LOCATION WIRE BOX
- NON-FREEZE YARD HYDRANT
- PRESSURE IRRIGATION, TEE & GATE VALVE
- PRESSURE IRRIGATION SERVICE
- GRAVITY IRRIGATION & STRUCTURE

PROPOSED UTILITY (CONT.)

- SANITARY SEWER & MANHOLE
- SANITARY SEWER SERVICE & CAP
- PRESSURE SEWER SERVICE & CLEANOUT
- PRESSURE SEWER & VALVE VAULT
- STORM DRAIN LINE, INLET & CATCH BASIN
- STORM DRAIN LINE & MANHOLE W/ VENTED LID
- JOINT TRENCH IN PROFILE
- CABLE & TELEPHONE RISERS
- JOINT TRENCH & DEVICE
- JUNCTION BOX & DUCT BANK
- NATURAL GAS LINE & METER
- NATURAL GAS LINE & RISER
- NATURAL GAS LINE & VALVE
- UNDERGROUND POWER
- OVERHEAD POWER & POLE
- LIGHT POLE
- TELEPHONE LINE & RISER
- FIBER OPTIC LINE & VAULT
- TELEPHONE DATA LINE
- CABLE & TV RISER

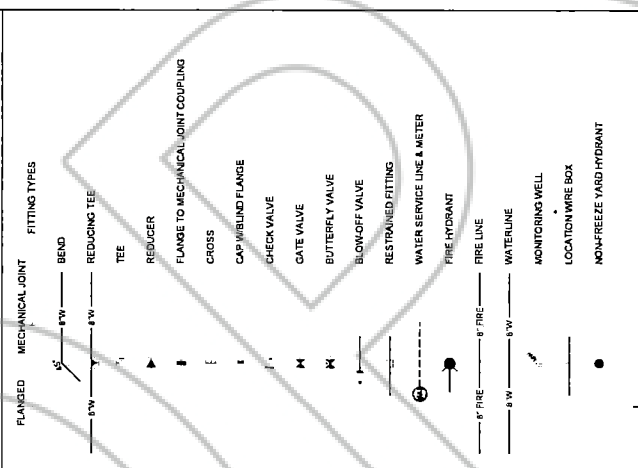

EXISTING TOPOGRAPHY

- TOPOGRAPHIC CONTOUR
- EDGE OF GRAVEL
- EDGE OF PAVEMENT
- CURB & GUTTER, SIDEWALK & DROP INLET
- FENCE (BARBED WIRE OR OTHER WITH GATES)
- FENCE (CHAINLINK WITH GATE)
- DITCH FLOWLINE
- TEST PIT
- SIGN
- BUILDING OR STRUCTURE

PROPERTY & CONTROL

- SURVEY CONTROL POINT
- BENCHMARK
- FOUND BRASS CAP
- FOUND ALUMINUM CAP
- FOUND 5" STEEL PIN
- FOUND 5/8" STEEL PIN W/CAP
- FOUND 1/2" STEEL PIN
- SET 1/2" 6" STEEL PIN W/CAP
- FOUND PK NAIL
- SET PK NAIL
- CALCULATED POINT
- WITNESS CORNER
- EASEMENT - UTILITY
- EASEMENT - TEMPORARY
- EASEMENT - SETBACK
- PROJECT BOUNDARY
- PROPERTY LINES

EXISTING UTILITY

- WATERLINE & VALVE
- SANITARY SEWER LINE & MANHOLE
- PRESSURE SEWER SERVICE & CLEANOUT
- PRESSURE SEWER LINE & VALVE VAULT
- STORM DRAIN LINE & MANHOLE
- PRESSURE IRRIGATION & VALVE
- GRAVITY IRRIGATION & MANHOLE
- OVERHEAD POWER LINE & POWER POLE
- UNDERGROUND POWER LINE
- SIGNAL POLE
- LIGHT POLE
- NATURAL GAS LINE
- FIBER OPTIC LINE
- TELEPHONE LINE & RISER
- CABLE LINE & RISER

PROPOSED GRADING


- TOPOGRAPHIC CONTOUR
- RIDGELINE
- DRAINAGE ARROW & SLOPE
- SPOT ELEVATION
- SWALE FLOWLINE
- DAYLIGHT - CUT LINE
- DAYLIGHT - FILL LINE



PROPOSED DEMOLITION, ABANDONMENT, REMOVAL

- DEMOLITION & REMOVAL
- ABANDON IN PLACE
- REMOVE SURFACE FEATURE
- CLEARING AND GRUBBING

PROPOSED SITE

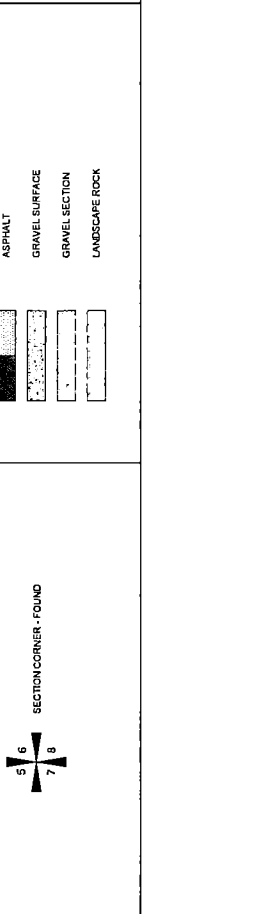- BUILDING OR STRUCTURE
- CONCRETE
- ASPHALT
- GRAVEL SURFACE
- GRAVEL SECTION
- LANDSCAPE ROCK




BENCHMARKS
 BM#1 - COTTON SPINDLE
 N = 1468027.81
 E = 238275.10
 EL = 4656.03
 BM#2 - COTTON SPINDLE "COTTON"
 N = 1468027.81
 E = 238275.10
 EL = 4656.03

SURVEY NOTES
 1. SEE TITLE SHEET FOR BASIS OF BEARING AND BASIS OF ELEVATIONS.
 2. BUREAU OF LAND MANAGEMENT RIGHT-OF-WAY GRANT WY 106177000.

SHEET KEYNOTES
 01. EXISTING UNIMPROVED ROAD SHALL BE MAINTAINED AS SIDE ACCESS TO THE PROJECT SITE.
 02. EXISTING TANK SITE SHALL BE AVAILABLE FOR CONSTRUCTION OF NEW TANK. THE STAGING AREA WILL BE PROVIDED BY THE COUNTY.
 03. BEGIN CONTRACTORS ACCESS FROM UNIMPROVED DRIVEWAY ON PORTER LANE NEAR 1394-1398 PORTER DRIVE.

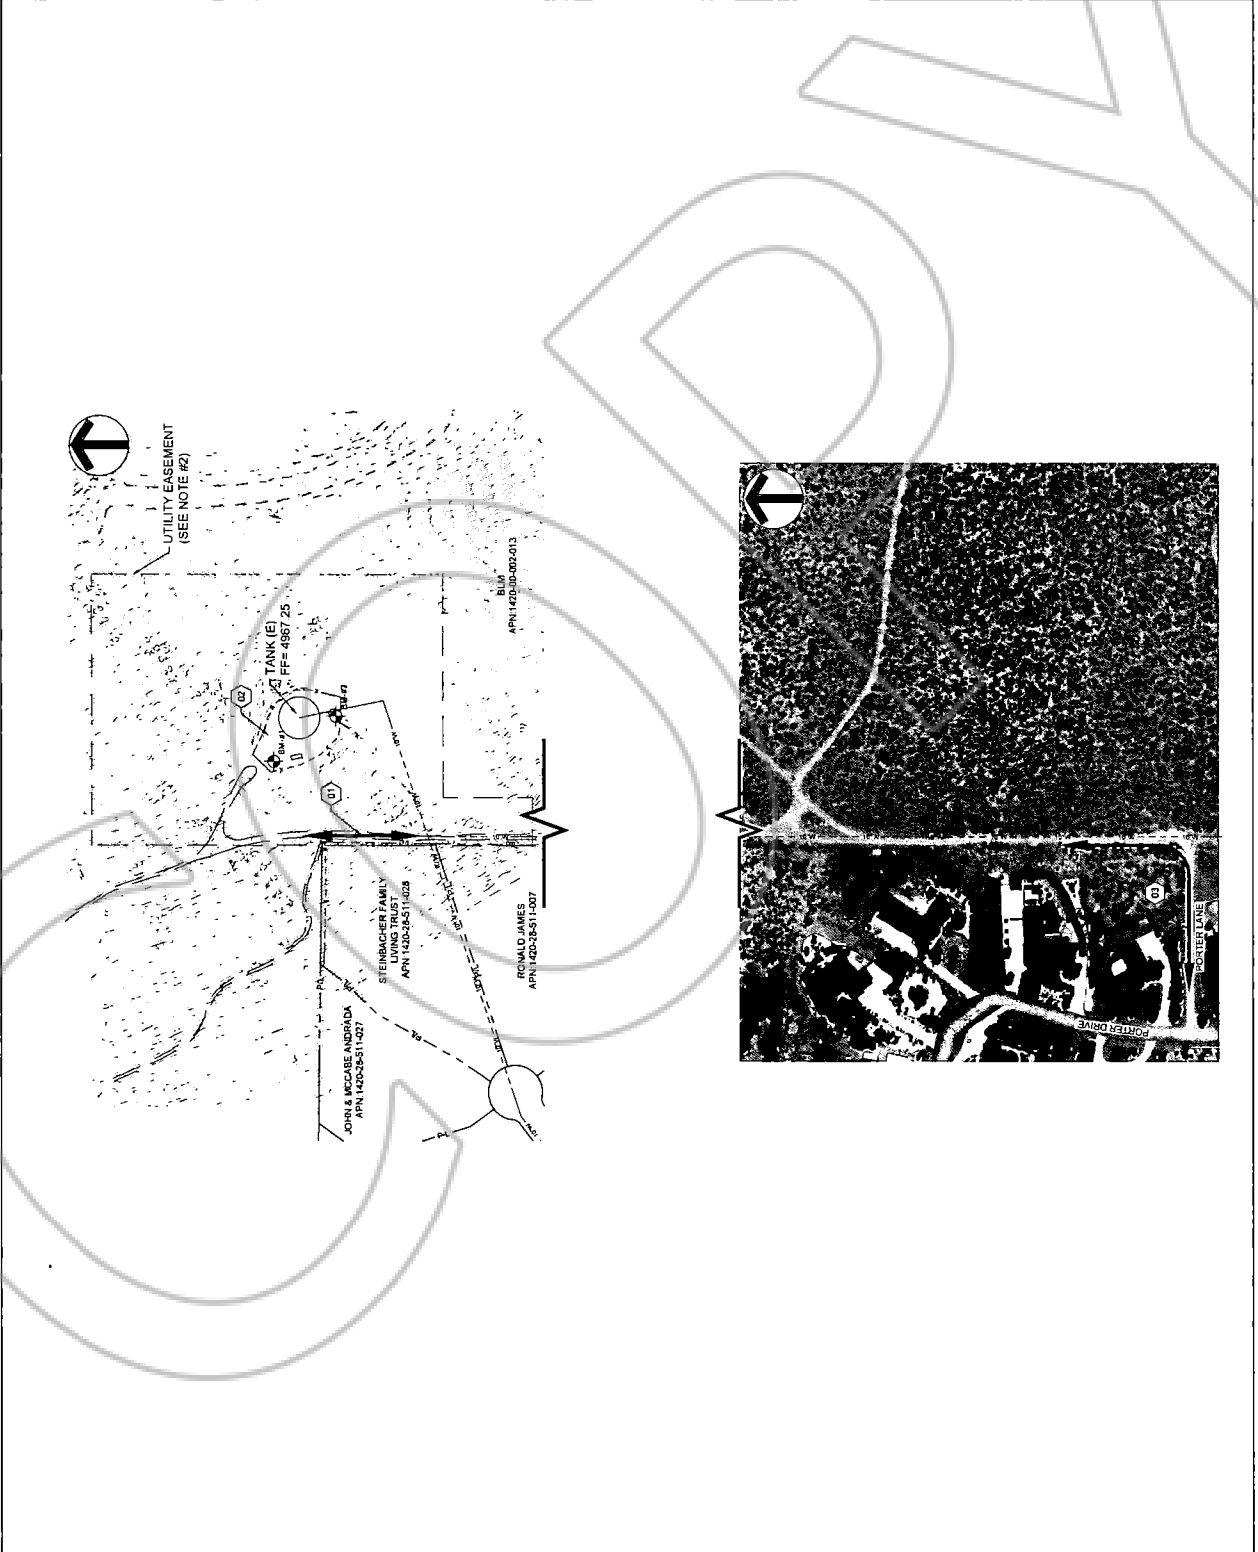

NO.	REVISIONS	DATE


LEGEND

REMOVE PIPES SHOWN IN RED
EXISTING STRUCTURE
TO BE DEMOLISHED

GENERAL SHEET NOTES

- PRIOR TO CONSTRUCTION, CONTRACTOR TO VERIFY LOCATION AND DEPTH OF ALL EXISTING UTILITIES TO VERIFICATION & DEPTH.
- REFER TO ELECTRICAL PLANS FOR ELECTRICAL DEMOLITION.
- DISPOSE OF DEMOLISHED STRUCTURES, EQUIPMENT, AND OTHER MATERIALS OFFSITE AT A LOCATION DETERMINED BY THE OWNER, IN ACCORDANCE WITH STATE AND FEDERAL REGULATIONS. OBTAIN AND FILE ALL NECESSARY PERMITS UNLESS NOTED OTHERWISE.
- CONTRACTOR IS RESPONSIBLE THAT WATER SYSTEM OPERATIONS ARE NOT INTERRUPTED AND SHALL COORDINATE ALL DEMOLITION ACTIVITIES WITH ENGINEER AND OWNER, RE OPERATIONAL AND ON-LINE PRIOR TO ANY TANK OR PIPING DEMOLITION ACTIVITIES.
- REFER TO SPECIFICATION (01.31.1) SPECIAL PROJECT PROCEDURES PRIOR TO PHASED DEMOLITION.
- USE APPROPRIATE MEANS, METHODS, AND SHORING FOR DEMOLITION. NO ADDITIONAL SHORING OR BRACING TO BE PROVIDED UNLESS PERFORMED IN ADDITION TO WHAT IS SHOWN.
- CONTRACTOR TO PROVIDE PERIMETER FENCING TO BE MAINTAINED THROUGHOUT THE PROJECT. CONTRACTOR TO COORDINATE WITH OWNER TO PROVIDE INTERIM FENCING AND GATES FOR THE DURATION OF THE PROJECT. FENCING TO BE MAINTAINED TO BE IMPACTED DURING CONSTRUCTION.
- PROVIDE ADEQUATE SOIL AND EROSION CONTROL PREVENTION MEASURES ON ALL DISTURBED PROJECT AREAS.

- SHEET KEYNOTES**
- REMOVE EXISTING FENCING.
 - REMOVE EXISTING GATE.
 - REMOVE EXISTING TANK, RE SPECIFICATIONS & GENERAL NOTE 3
 - EXISTING ELECTRICAL ENCLOSURE, RE. E-120
 - EXISTING DIRT ROAD TO BE MODIFIED & REPLACED WITH NEW GRAVEL ROAD, RE. C-110
 - REMOVE EXISTING WATER PIPE.
 - REMOVE EXISTING VALVE
 - INSTALL TEMPORARY FILL STATION, RE. XVIC-SXX
 - ABANDON PIPE TO REMAIN UNLESS IMPACTED BY NEW CONSTRUCTION (CUT & REMOVE PIPE AS NEEDED, CAP ABANDONED ENDS (NO THRUST BLOCK))
 - MODIFY EXISTING VALVE VAULT, RE. C-501
 - RETAIN & PROTECT EXISTING VALVE & PIPING

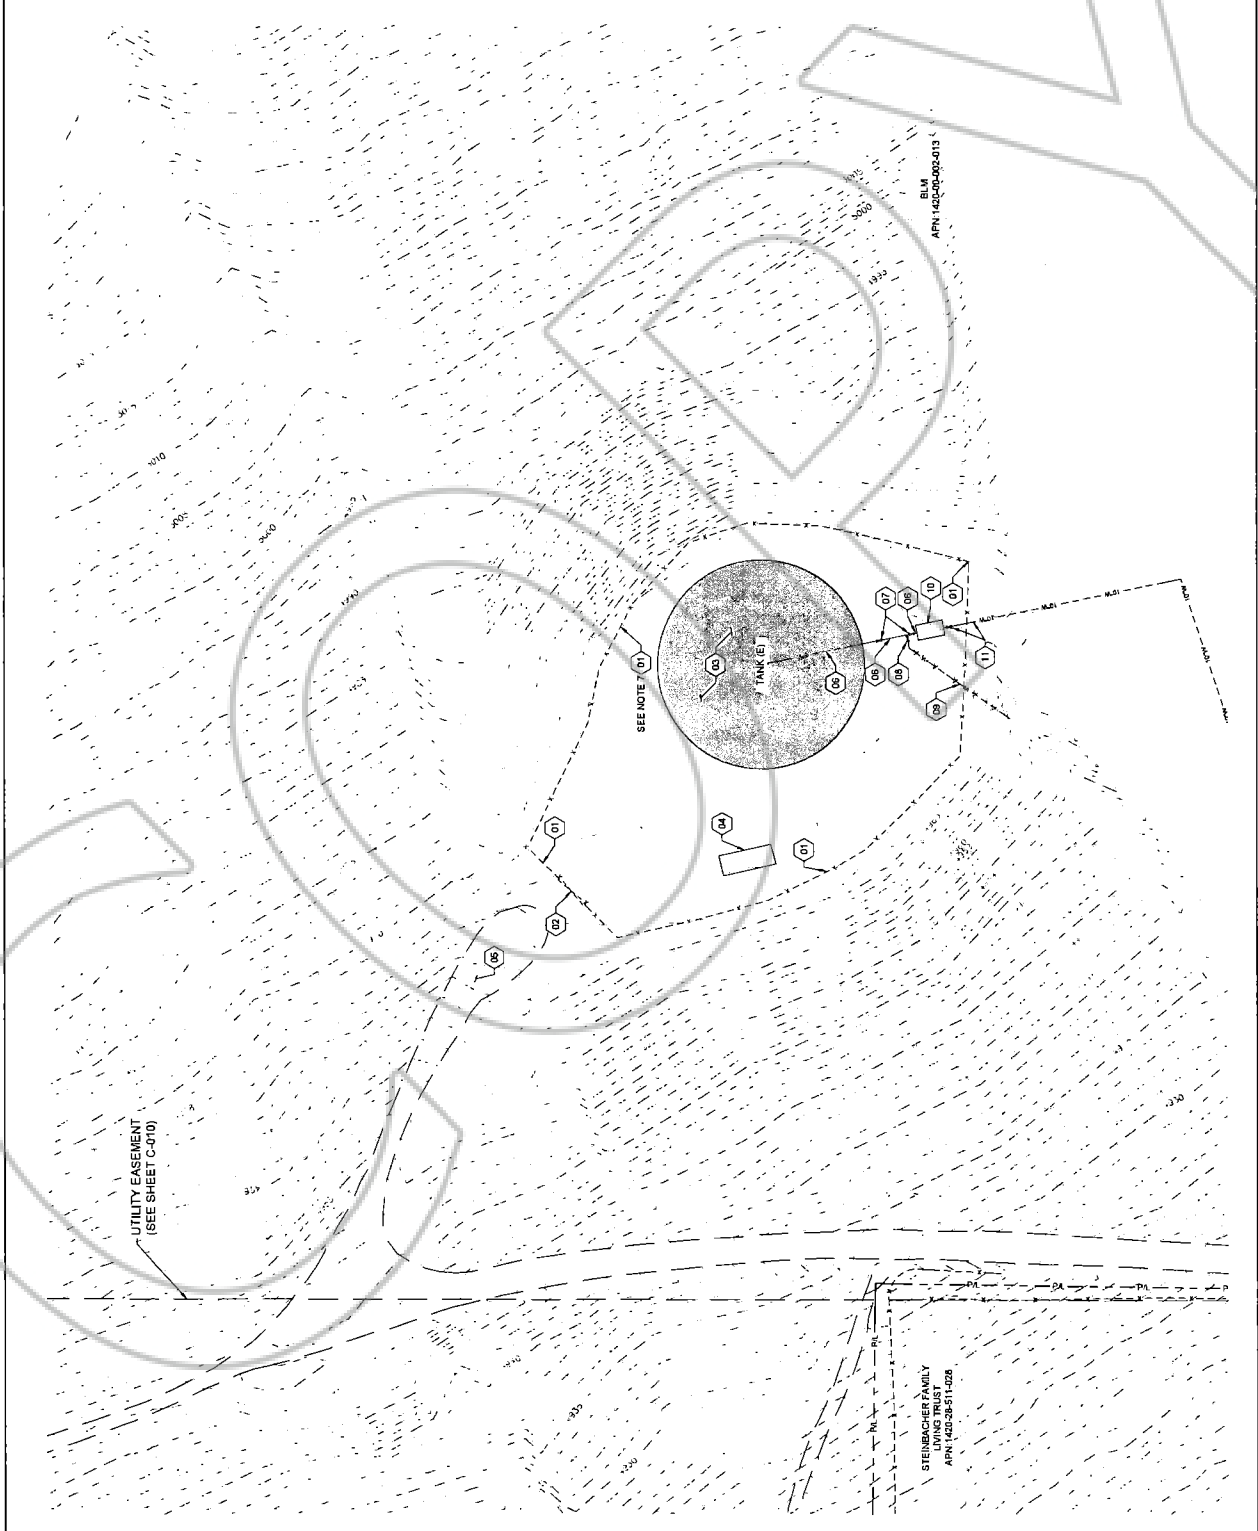

KELLER ASSOCIATES
 2225 Mountain View Square, 3rd Fl.
 Suite 300, San Jose, CA 95128
 (408) 434-7288


500 - Estimate
 Review
 Not for
 Construction

NO REVISIONS
 DATE: _____
 This document is not intended to detail or design
 unless the building project is fully developed.
 with authorization of Keller Associates, Inc.

DOUGLAS COUNTY, NEVADA


MOUNTAIN VIEW WATER TANK REPLACEMENT
SITE PLAN KEY MAP

DRAWN - J. CHECKER 2/01
 VERIFY SCALE. SOME
 DIMENSIONS MAY VARY
 BASED ON 22x34x11 PRINTS
 PROJECT NO. 223125
 SHEET NO. C-100

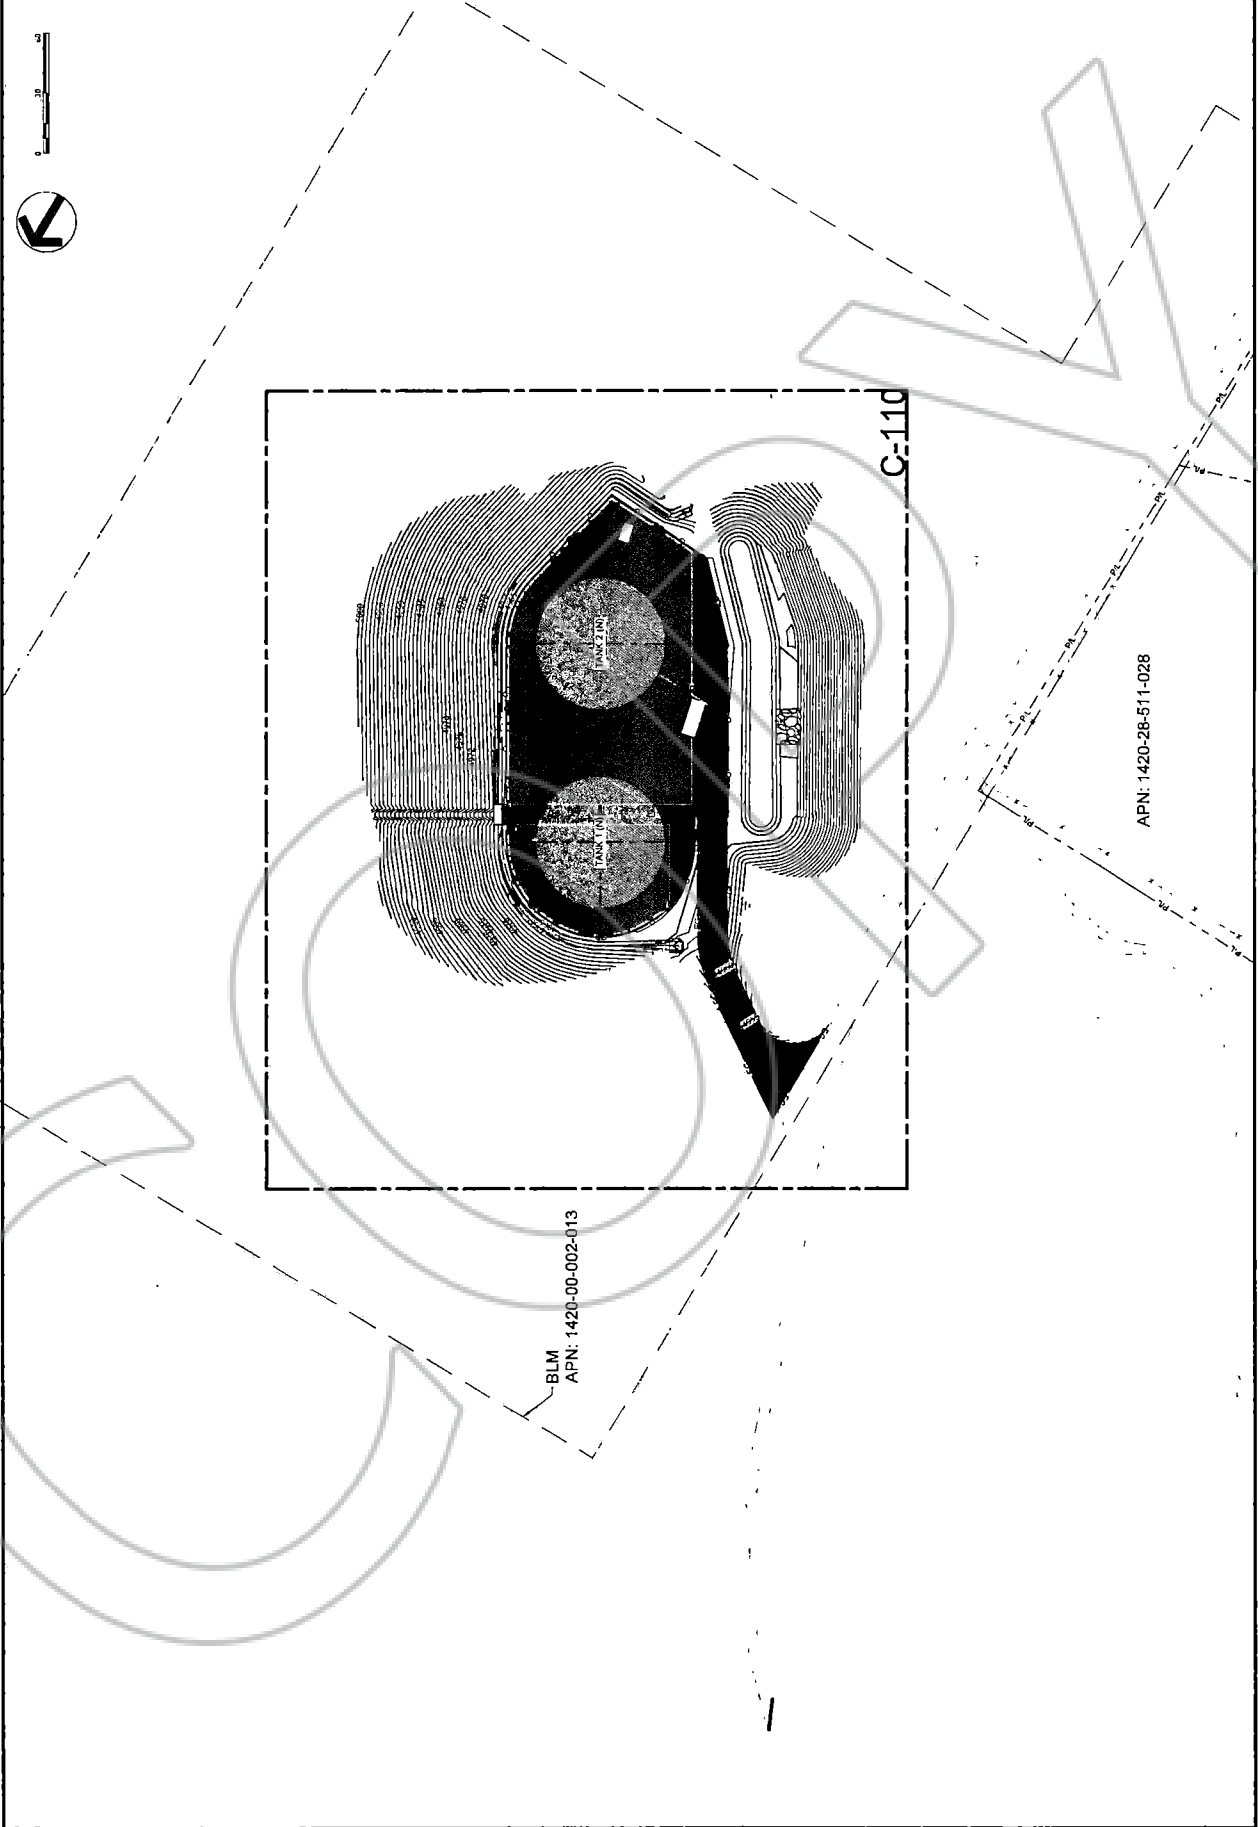

05 - Design
 Review
 Not for
 Construction

NO REVISIONS
 DATE
 THIS DOCUMENT IS THE PROPERTY OF KELLER ASSOCIATES, INC. AND IS NOT TO BE REPRODUCED OR TRANSMITTED IN ANY FORM OR BY ANY MEANS, ELECTRONIC OR MECHANICAL, INCLUDING PHOTOCOPYING, RECORDING, OR BY ANY INFORMATION STORAGE AND RETRIEVAL SYSTEM.

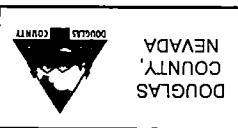


GENERAL SHEET NOTES

- AREAS DISTURBED BY CONSTRUCTION WHERE SURFACE REPAIR IS NOT INDICATED SHALL BE RESTORED TO CONDITIONS FOUND PRIOR TO CONSTRUCTION. REPAIRS SHALL BE INCIDENTAL TO THE CONTRACT.
- CONTRACTOR TO FURNISH ALL MATERIALS UNLESS NOTED OTHERWISE.
- VERIFY DISTANCE BETWEEN COORDINATES AND EXISTING UTILITIES PRIOR TO CONSTRUCTION.

- SHEET KEYNOTES**
- CONSTRUCT GRAVEL SURFACING, RE C4C-510
 - INSTALL 3 STRAND CHAIN LINK FENCE, RE A1C-510
 - INSTALL 12" CHAIN LINK SINGLE SWING GATE, RE A3C-510
 - INSTALL 18" CHAIN LINK DOUBLE SWING GATE, RE A3C-510
 - CONCRETE 1/2" SMALL, SEE C400 FOR PIPE CONTINUATION
 - CONSTRUCT PERMETER DRAINAGE DITCH, RE C400-510
 - CONSTRUCT DRAINAGE DITCH, RE C1C-510
 - INSTALL CONCRETE ENERGY DISSIPATION STRUCTURE, RE A1C-511
 - CONSTRUCT CONCRETE HEADWALL, RE A2C-511
 - ELECTRICAL ENCLOSURE, RE E-100
 - INSTALL TEMPORARY ANTENNA TOWER, RE E-100
 - EXISTING TO REMAIN WATER VAULT, RE C-501
 - OVERFLOW BASIN
 - EMERGENCY SPILLWAY, RE A4C-510


STRUCTURE COORDINATES

POINT #	EASTING	NORTHING	DESCRIPTION
1	1465033.38	2298313.21	EDGE GRAVEL
2	1465033.38	2298313.21	EDGE GRAVEL
3	1465033.38	2298313.21	EDGE GRAVEL
4	1465033.38	2298313.21	EDGE GRAVEL
5	1465033.38	2298313.21	EDGE GRAVEL
6	1465033.38	2298313.21	EDGE GRAVEL
7	1465033.38	2298313.21	EDGE GRAVEL
8	1465033.38	2298313.21	EDGE GRAVEL
9	1465033.38	2298313.21	EDGE GRAVEL
10	1465033.38	2298313.21	EDGE GRAVEL
11	1465033.38	2298313.21	EDGE GRAVEL
12	1465033.38	2298313.21	EDGE GRAVEL
13	1465033.38	2298313.21	EDGE GRAVEL
14	1465033.38	2298313.21	EDGE GRAVEL
15	1465033.38	2298313.21	EDGE GRAVEL
16	1465033.38	2298313.21	EDGE GRAVEL
17	1465033.38	2298313.21	EDGE GRAVEL
18	1465033.38	2298313.21	EDGE GRAVEL
19	1465033.38	2298313.21	EDGE GRAVEL

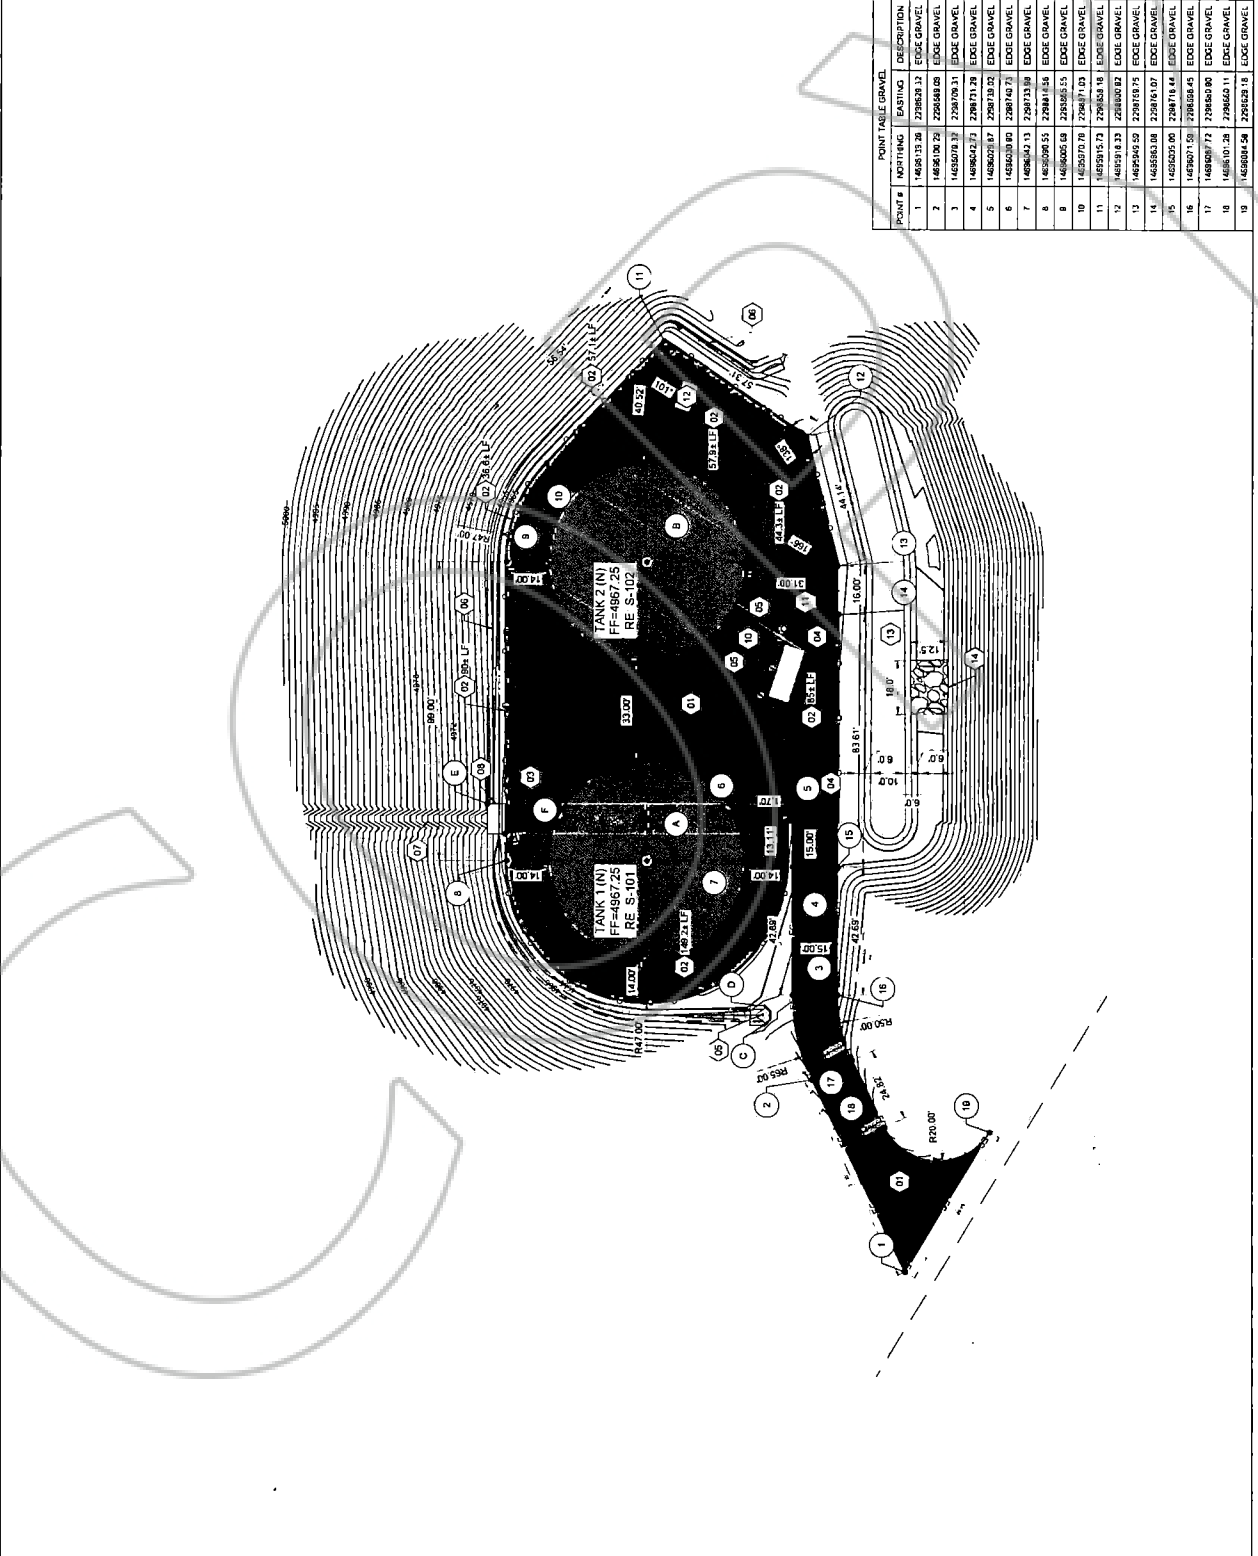

NO.	REVISIONS	DATE

This document or any part thereof is the property of Keller Associates, Inc. and shall not be copied or used in detail or design without the written authorization of Keller Associates, Inc.

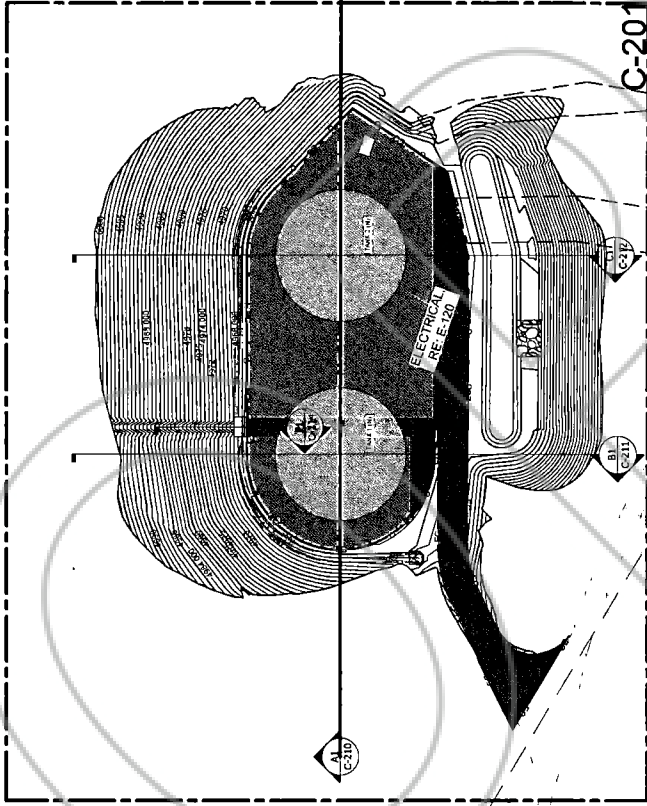

BLM
 APN: 1420-00-002-013

APN: 1420-28-511-028

C-201

BLM
 C-210

BLM
 C-211



NO.	DATE	REVISIONS


90% Design
Review
Not For
Construction

ABBREVIATIONS

- AC - TOP OF ASPHALT
- CON - TOP OF CONCRETE
- FF - FINISHED FLOOR
- FG - FINISHED GRADE
- GLB - GRADE BREAK
- GWL - EDGE OF GRAVEL
- HW - HIGH WATER
- FTW - FINISHED TOP WALK
- TBC - TOP BACK OF CURB
- TBW - TOP OF SIDEWALK
- TOW - TOP OF WALL

SHEET KEYNOTES



- 01 MATCH EXISTING GRADES ENTIRE EDGE
- 02 CLEAR, GRUB & FILL IN ERODED DRAINAGE AREA TO CREATE A SMOOTH CROSS SECTION. REPAIR TO VEGETATION OUTSIDE ERODED CHANNEL
- 03 INSTALL CONCRETE EMERGENCY RESERVOIR STRUCTURE. RE ALCS-11 FOR GENERAL GRADING ELEVATIONS AND DIMENSIONS
- 04 CONCRETE HEADWALL. SEE CAD FOR PIPE CONTINUATION
- 05 TRANSVERSE DITCH. WIDE BOTTOM, 1.25' SIDE SLOPES. 1% DRAIN
- 06 THE PROPOSED V-DITCH (2.1' SIDE SLOPES, 1' SIDE SLOPES). SEE CAD FOR GENERAL GRADING AND GROUNDING HAS OCCURRED
- 07 CONNECT INTO EXISTING DRAINAGE DITCH (ELEVATION = 4682.5)
- 08 EMERGENCY SPILLWAY. RE AMCS-10
- 09 OVERFLOW BASIN
 - TOP OF DINE = 4685.00
 - HIGH WATER = 4684.0
 - LOW WATER = 4682.50
 - VOLUME = 65,000 GAL.
- 10 PROVIDE SLOPE STABILIZATION AS REQUIRED

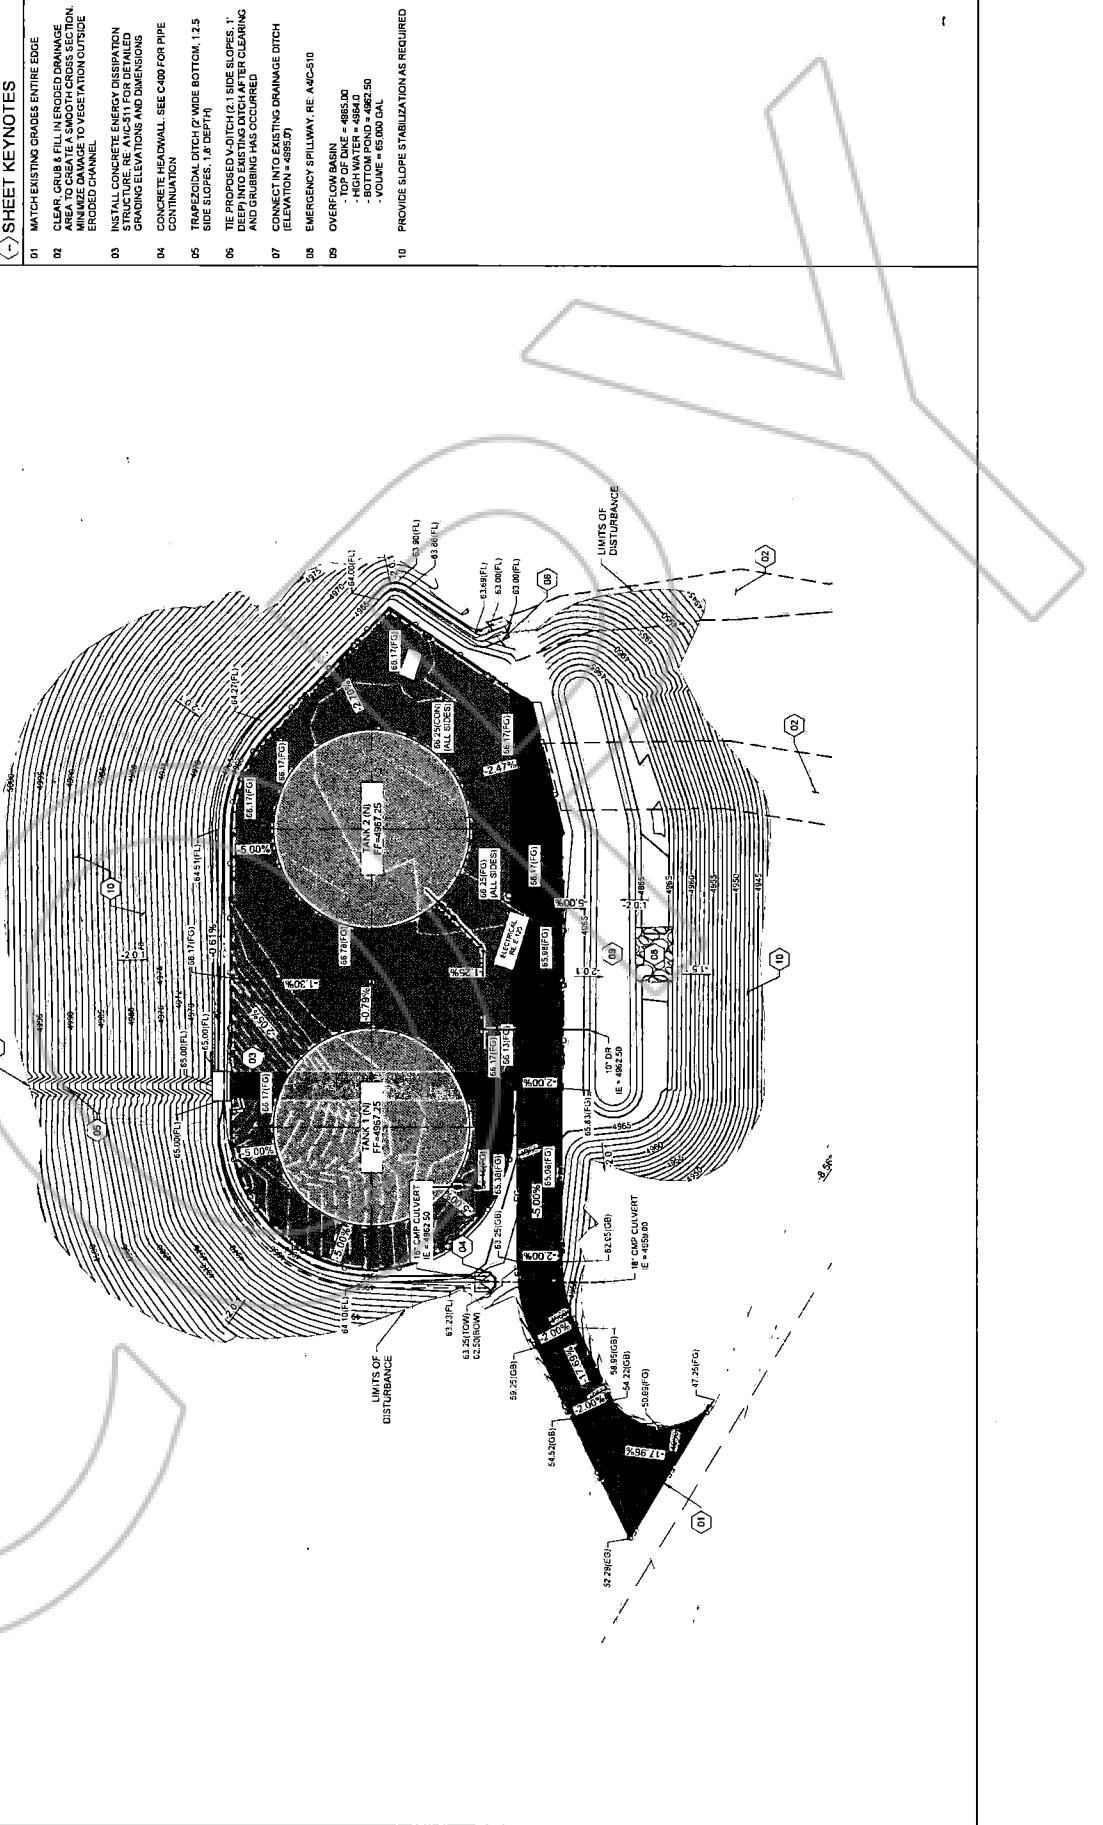

NO.	REVISIONS	DATE

ABBREVIATIONS

- AC - TOP OF ASPHALT
- CCM - TOP OF CONCRETE
- FF - FINISHED FLOOR
- FL - FINISHED GRADE
- CG - CURB GRADE
- G.B. - GRADE BREAK
- GVL - EDGE OF GRAVEL
- GVW - GRAVEL WALKWAY
- KTW - RETAINING WALL
- TBC - TOP BACK OF CURB
- TBW - TOP OF SIDEWALK
- TOW - TOP OF WALL

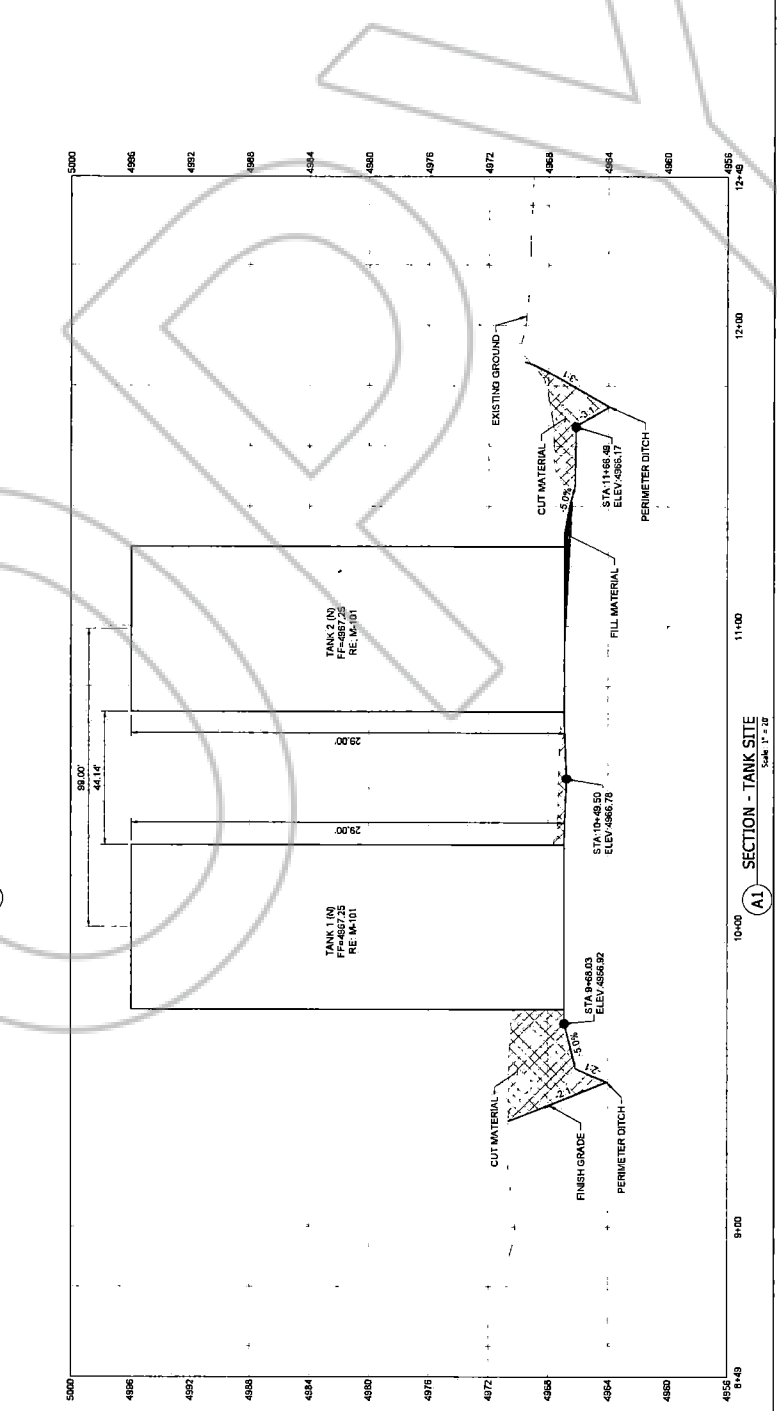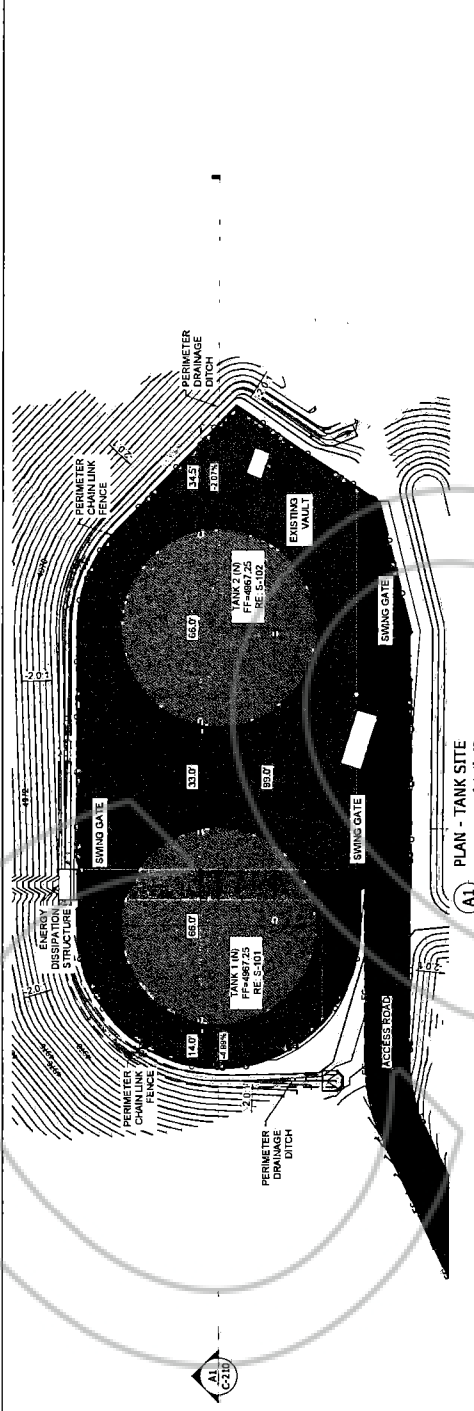


90% Design
 Review
 Not For
 Construction

NO. OF REVISIONS	DATE

This document is the property of Keller Associates, Inc. and shall not be copied or reproduced in any form without the written authorization of Keller Associates, Inc.

MOUNTAIN VIEW WATER TANK REPLACEMENT
TANK 1 CROSS SECTION

DRAWN BY: JK/CHECK BY: JW
VERIFY SCALE: Scale based on 22'x34' print.
PROJECT NO. 223125
SHEET NO. C-211

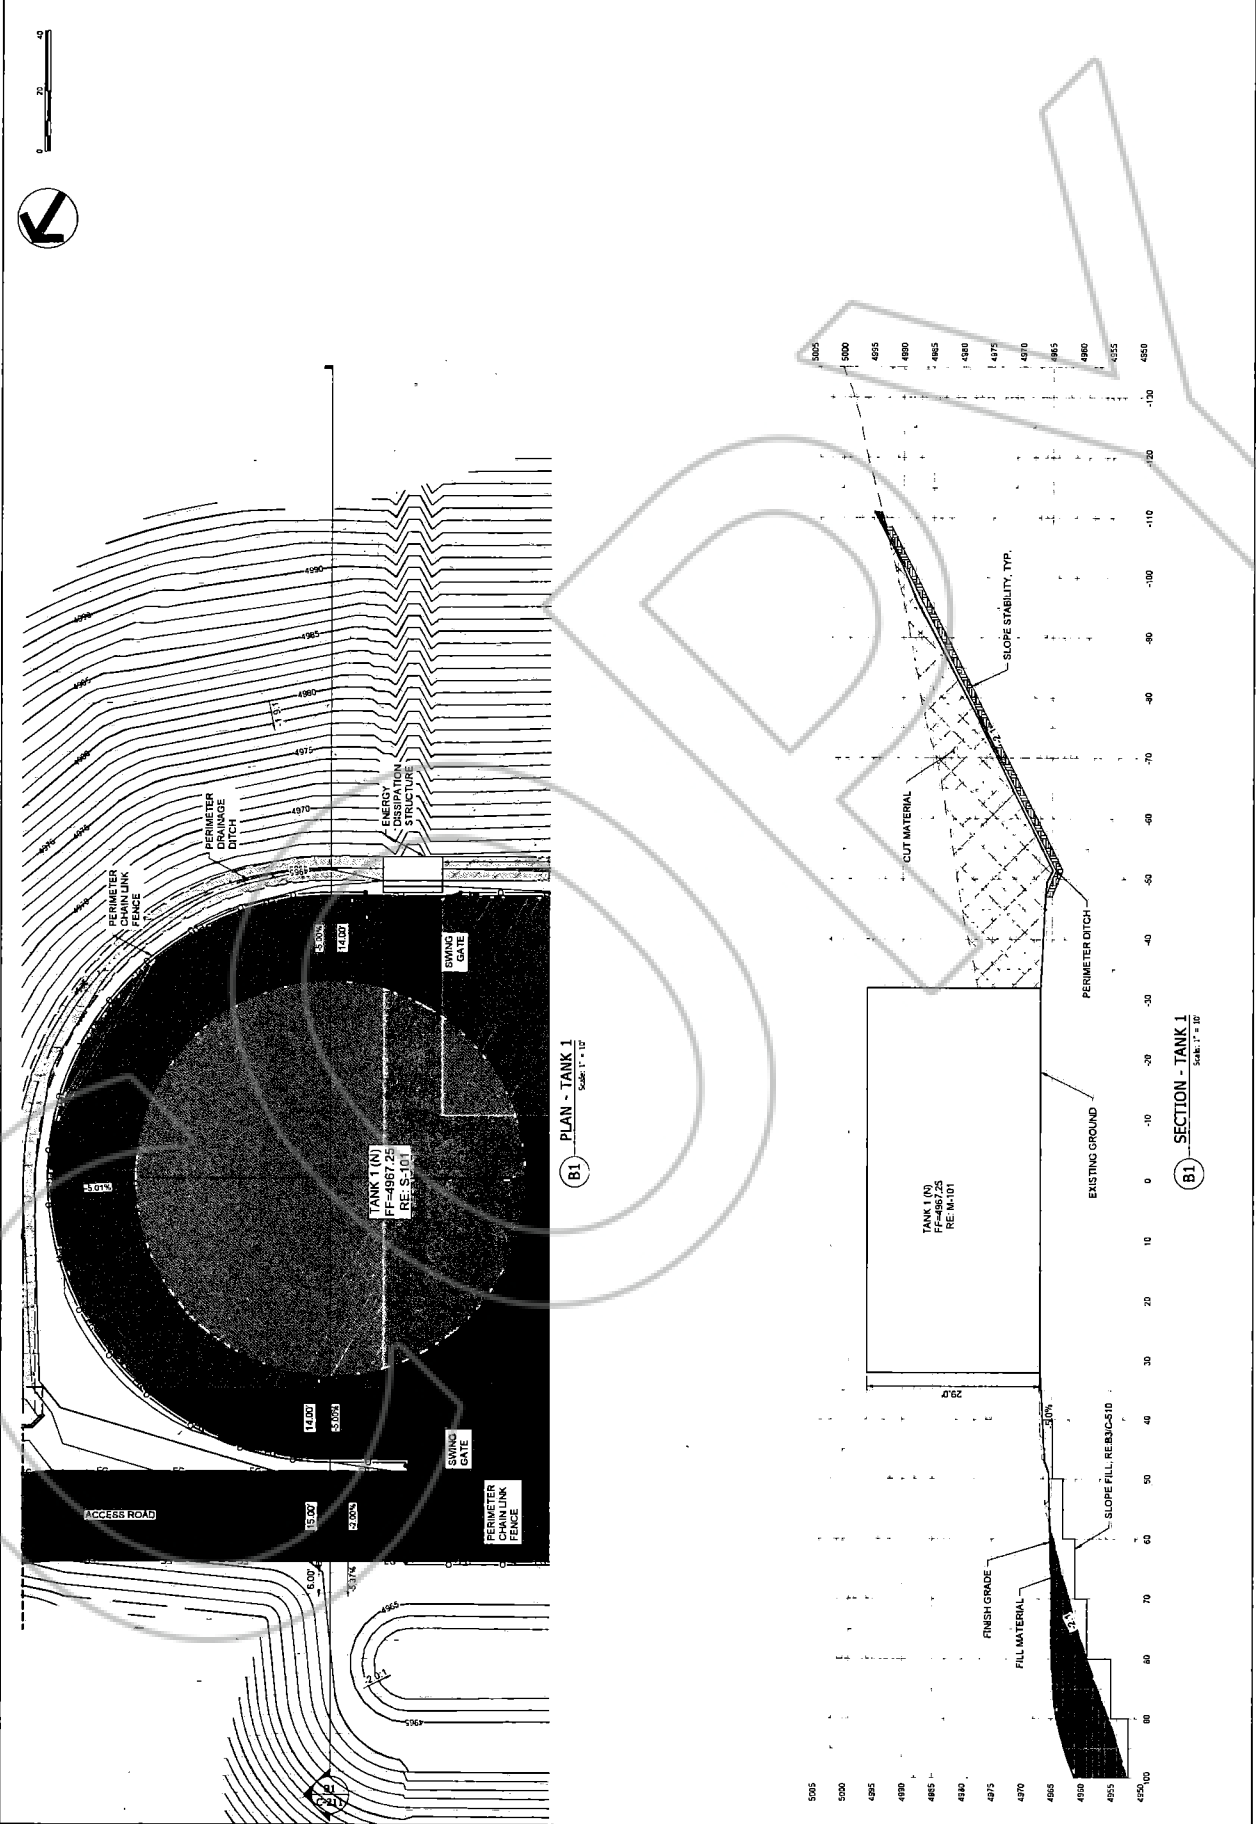



90% Design
 Review
 Not For
 Construction



NO.	REVISIONS	DATE



DOUGLAS
 COUNTY,
 NEVADA

MOUNTAIN VIEW WATER TANK
 REPLACEMENT
 TANK 2 CROSS SECTION


DRAWN	JR/CHKD	JW
VERIFY SCALE SHEETS BASED ON 223125.PINPLN.		
PROJECT NO.	223125	
SHEET NO.	C-212	

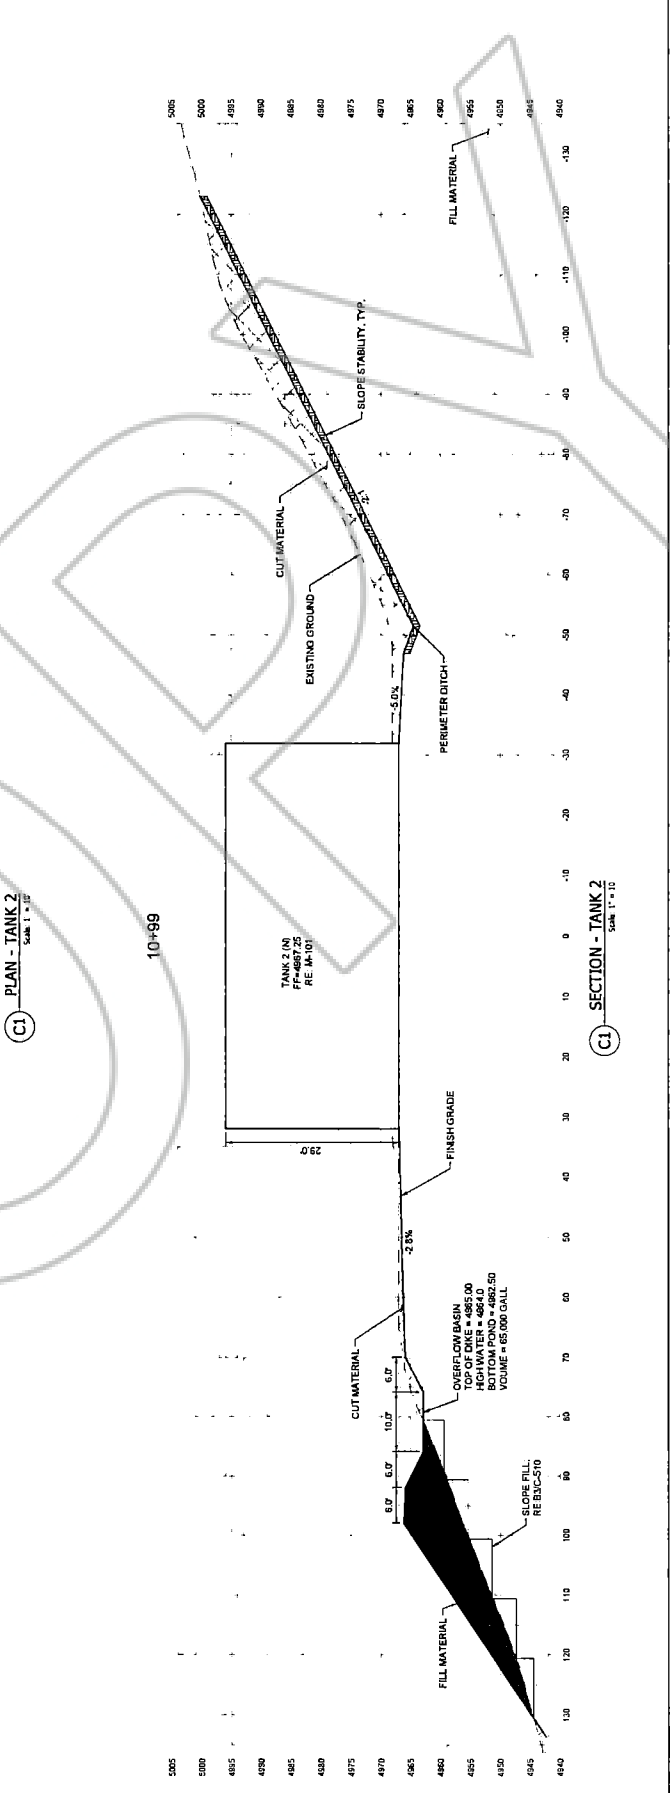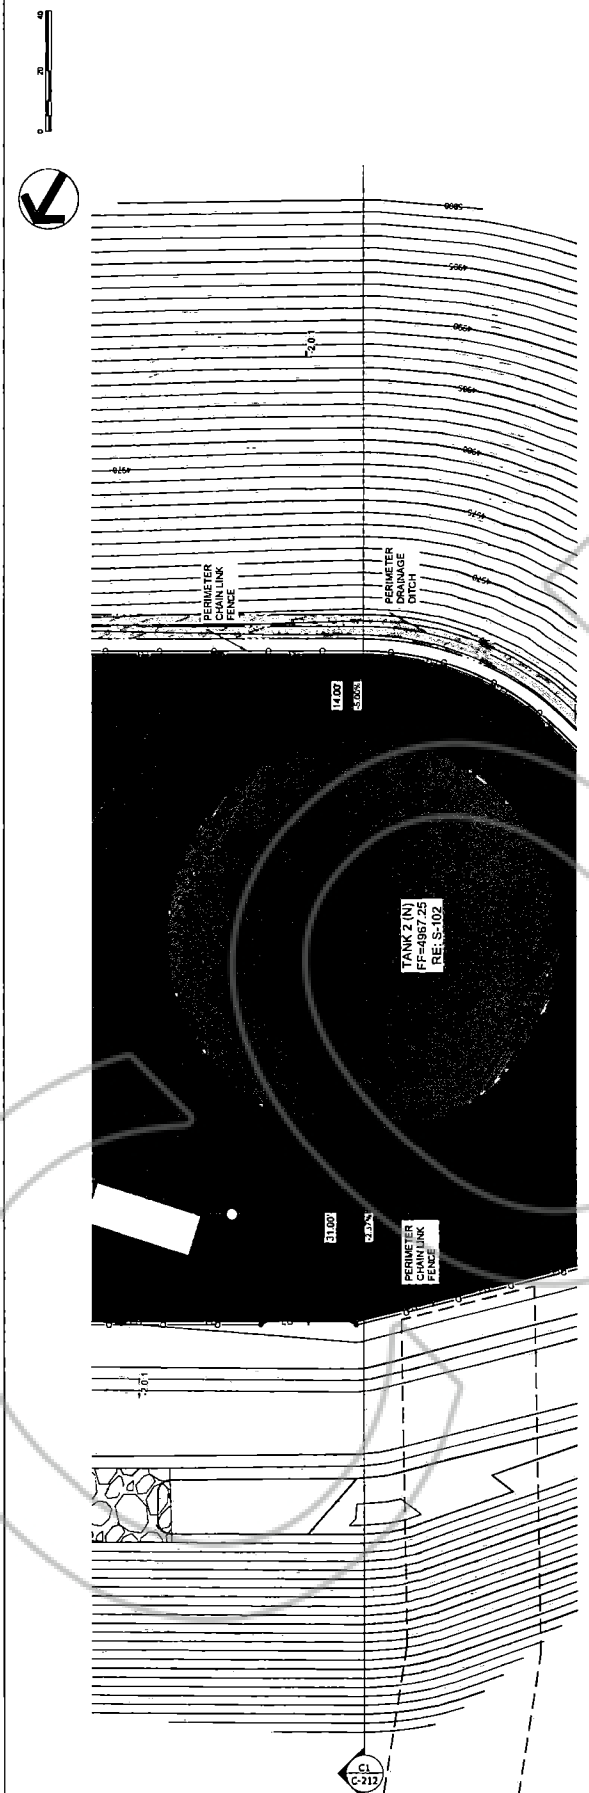



10% Design
Review
Not for
Construction

NO. _____
REVISIONS _____
DATE _____
written authorization of Keller Associates, Inc.
The documents of any part thereof in whole or in part
constitute the general contract of Keller Associates, Inc.
and shall be subject to the terms and conditions of the
contract.

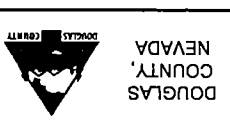


MOUNTAIN VIEW WATER TANK
REPLACEMENT
ENERGY DISSIPATION SECTION

DRAWN BY: CHECKED BY:
VERIFY SCALE: Stamps based on 24"x36" prints.
PROJECT NO. 223125
PAGE
SHEET NO. C-214


ABBREVIATIONS

AC - TOP OF ASPHALT
CON - TOP OF CONCRETE
FF - FINISHED FLOOR
FG - FINISHED GRADE
G.B. - GRADE BREAK
G.W. - EDGE OF GRAVEL
RTW - RETAINING WALL
TBC - TOP BACK OF CURB
TOW - TOP OF WALK
TOW - TOP OF WALL

SHEET KEYNOTES

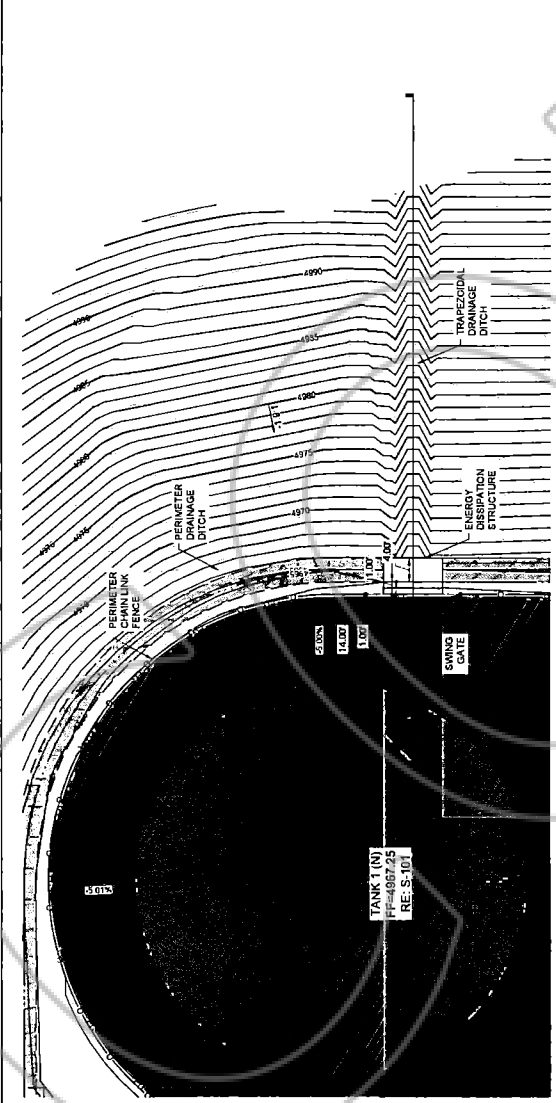

(F1) PLAN - ENERGY DISSIPATOR
Scale: 1" = 10'

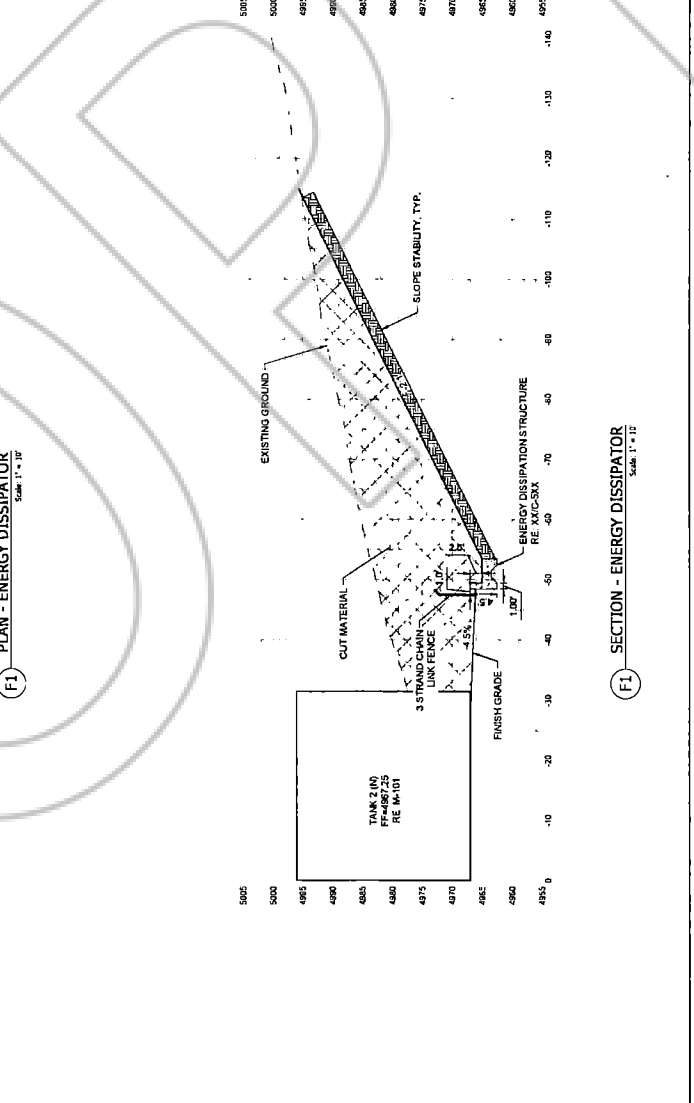

(F1) SECTION - ENERGY DISSIPATOR
Scale: 1" = 12'



50% Design
 Review
 Not For
 Construction


NO.	REVISIONS	DATE



DOUGLAS
 COUNTY,
 NEVADA

MOUNTAIN VIEW WATER TANK
 REPLACEMENT
 YARD PIPING KEY MAP


DRAWN: JH	CHECK: JW
VERIFY SCALE: Soils based on 22x4x prisms	
SCALE: 1"=100'	
PROJECT NO:	223125
SHEET NO:	C-400

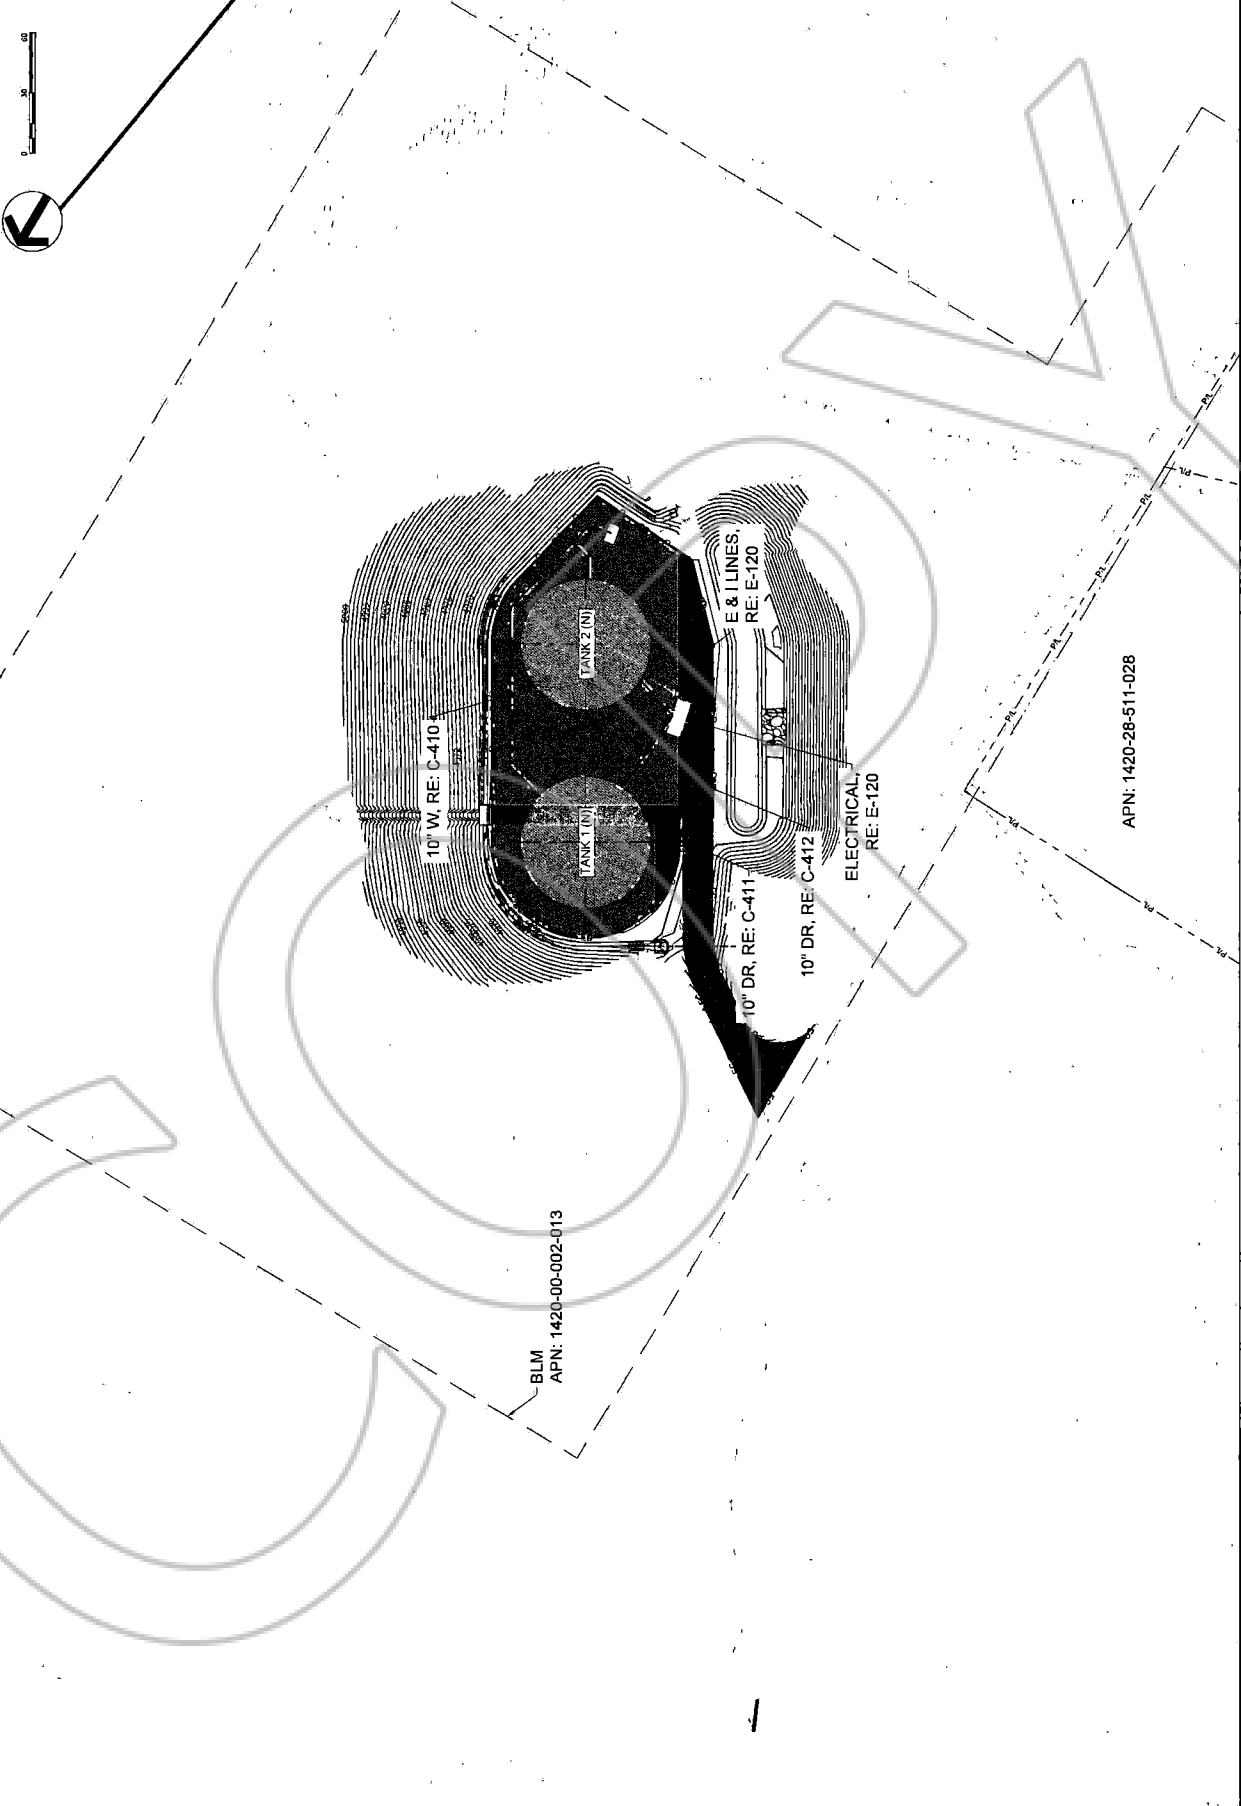

10'
 0'
 5'

BLM
 APN: 1420-00-002-013

APN: 1420-28-511-028


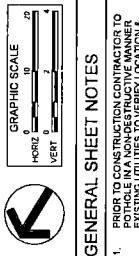



GENERAL SHEET NOTES

- PRIOR TO CONSTRUCTION CONTRACTOR TO FORTHOLE IN A NON-DESTRUCTIVE MANNER EXISTING UTILITIES TO VERIFY LOCATION & DEPTH. CONTRACTOR SHALL BE RESPONSIBLE FOR ANY ENCOUNTERED UTILITIES. IT IS RECOMMENDED THAT THE CONTRACTOR HIRE A GROUND PENETRATING RADAR (GPR) OR VACUUM TRUCK TO LOCATE UTILITIES PRIOR TO EXCAVATION IN THESE AREAS.
- CONTRACTOR TO PORTABLE AND LOCATE ALL PIPE CONNECTIONS TO VERIFY PIPE LENGTHS PRIOR TO ORDERING MATERIALS.
- AREAS DISTURBED BY CONSTRUCTION WHERE SURFACE REPAIRS ARE NOT INDICATED SHALL BE REPAIRED TO ORIGINAL FINISH AND TO MATCH THE ADJACENT AREAS PRIOR TO CONSTRUCTION.
- ABANDONED UTILITY PIPING TO REMAIN UNLESS IMPACTED BY NEW CONSTRUCTION. CONTRACTOR TO PLUG ENDS OF EXPOSED PIPING.
- PROVIDE MECHANICALLY RESTRAINED JOINTS SURFACE REPAIRS TO BE MADE TO MATCH THE ADJACENT AREAS IN ALL DIRECTIONS. CHANGE IN DIRECTION. RE: SPECIFICATIONS.
- HORIZONTAL & VERTICAL LOCATION OF EXISTING UTILITIES ARE APPROXIMATE. SEE GENERAL NOTE #1.
- CONTRACTOR TO FURNISH ALL MATERIALS UNLESS NOTED OTHERWISE.

SHEET KEYNOTES

- INSTALL PIPE - 10" W
- INSTALL FITTING - 10" 22.5' BEND RE DOUGLAS COUNTY STD B12
- INSTALL FITTING - 10" 45' BEND RE DOUGLAS COUNTY STD B12
- INSTALL FITTING - 10" TEE RE DOUGLAS COUNTY STD B12
- INSTALL FITTING - 10" FLEXIBLE COUPLING TYPE II
- INSTALL VALVE - 10" GATE WITH VALVE BOX & LID RE DOUGLAS COUNTY STD DETAILS B10 & B11
- EXISTING VAULT MODIFICATIONS. RE A11C-S01
- ABANDONED UTILITY PIPING. RE C10C-S10

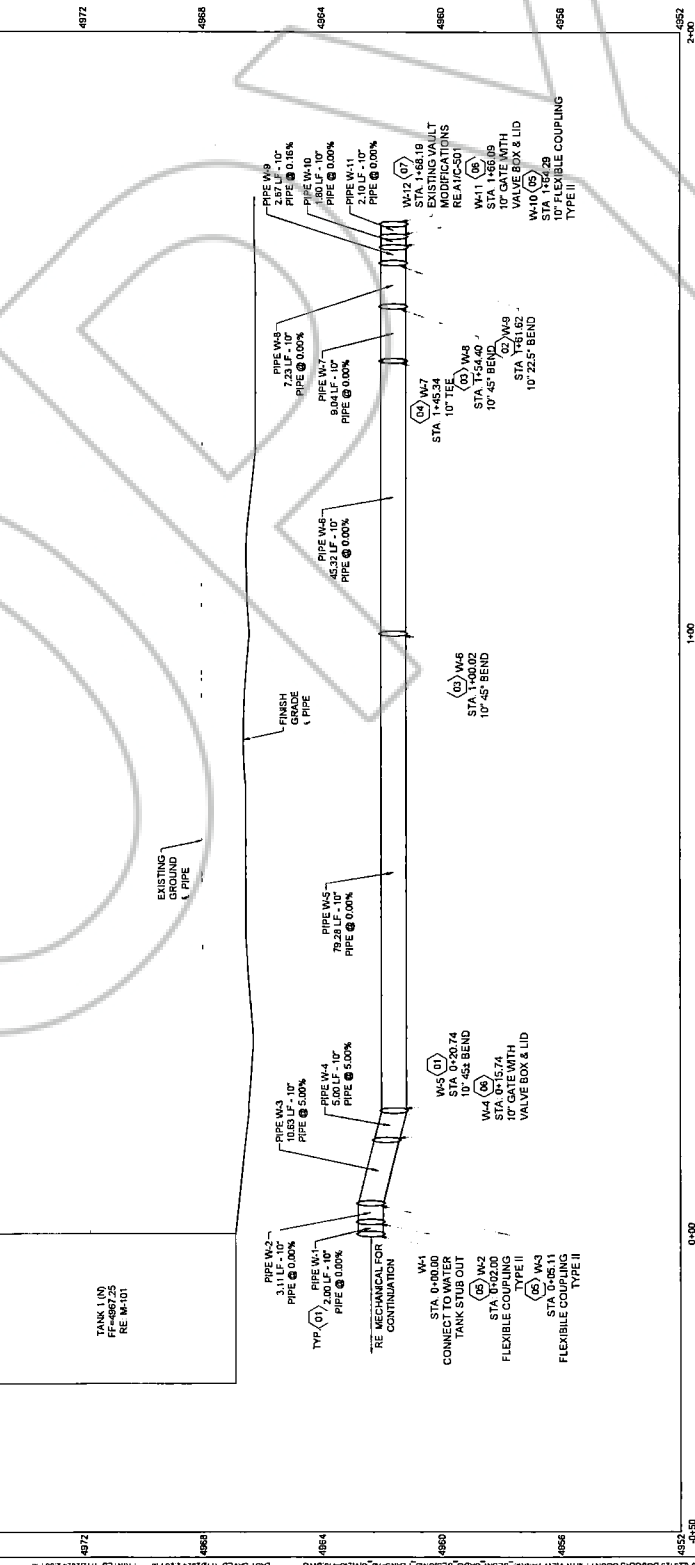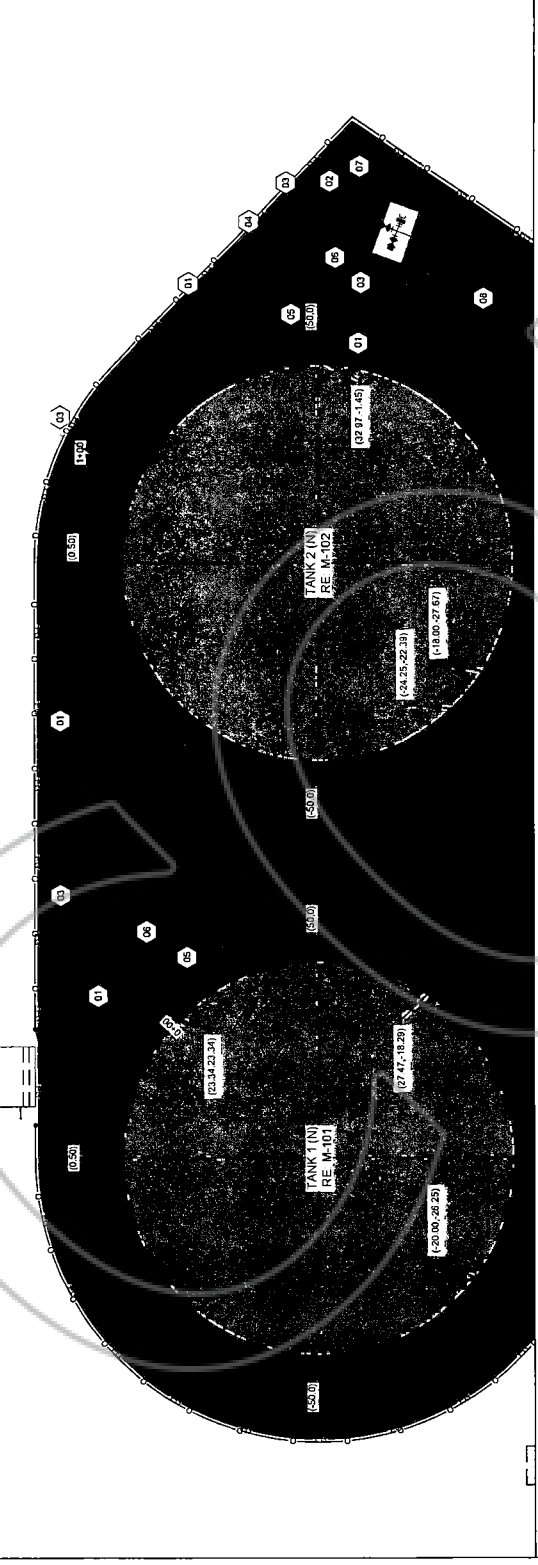


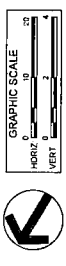



GENERAL SHEET NOTES

1. PRIOR TO CONSTRUCTION CONTRACTOR TO POthOLE IN A NON-DESTRUCTIVE MANNER EXISTING UTILITIES TO VERIFY LOCATION & DEPTH. CONTRACTOR SHALL BE RESPONSIBLE FOR ENCOUNTERED IT IS RECOMMENDED THAT THE CONTRACTOR HIRE A GROUND PENETRATING RADAR (GPR) TO VERIFY LOCATION & DEPTH OF UTILITIES IN THESE AREAS.
2. CONTRACTOR TO POthOLE AND LOCATE ALL PIPE CONNECTIONS TO VERIFY PIPE LENGTHS PRIOR TO ORDERING MATERIALS.
3. AREAS DISTURBED BY CONSTRUCTION WHERE RESTORATION REPAIR IS NOT INDICATED SHALL BE RESTORED TO ORIGINAL CONDITION AFTER CONSTRUCTION.
4. ASHROUDED UTILITY PIPING TO REMAIN UNLESS IMPACTED BY NEW CONSTRUCTION. CONTRACTOR TO PLUG ENDS OF EXPOSED PIPING.
5. PROVIDE MECHANICALLY RESTRAINED JOINTS UNLESS OTHERWISE NOTED. PROVIDE MECHANICAL CHANGE IN DIRECTION, RE SPECIFICATIONS.
6. HORIZONTAL & VERTICAL LOCATION OF EXISTING UTILITIES ARE APPROXIMATE. SEE GENERAL NOTE #1.
7. CONTRACTOR TO FURNISH ALL MATERIALS UNLESS NOTED OTHERWISE.

SHEET KEYNOTES

- 01 INSTALL PIPE - 10" DR
- 02 INSTALL FITTINGS - 10" 45° BEND RE DOUGLAS COUNTY STD B12
- 03 INSTALL FITTINGS - 10" TEE RE DOUGLAS COUNTY STD B12
- 04 INSTALL FITTING - 10" FLEXIBLE COUPLING TYPE II
- 05 INSTALL VALVE - 10" GATE WITH VALVE BOX & LID RE DOUGLAS COUNTY STD B12

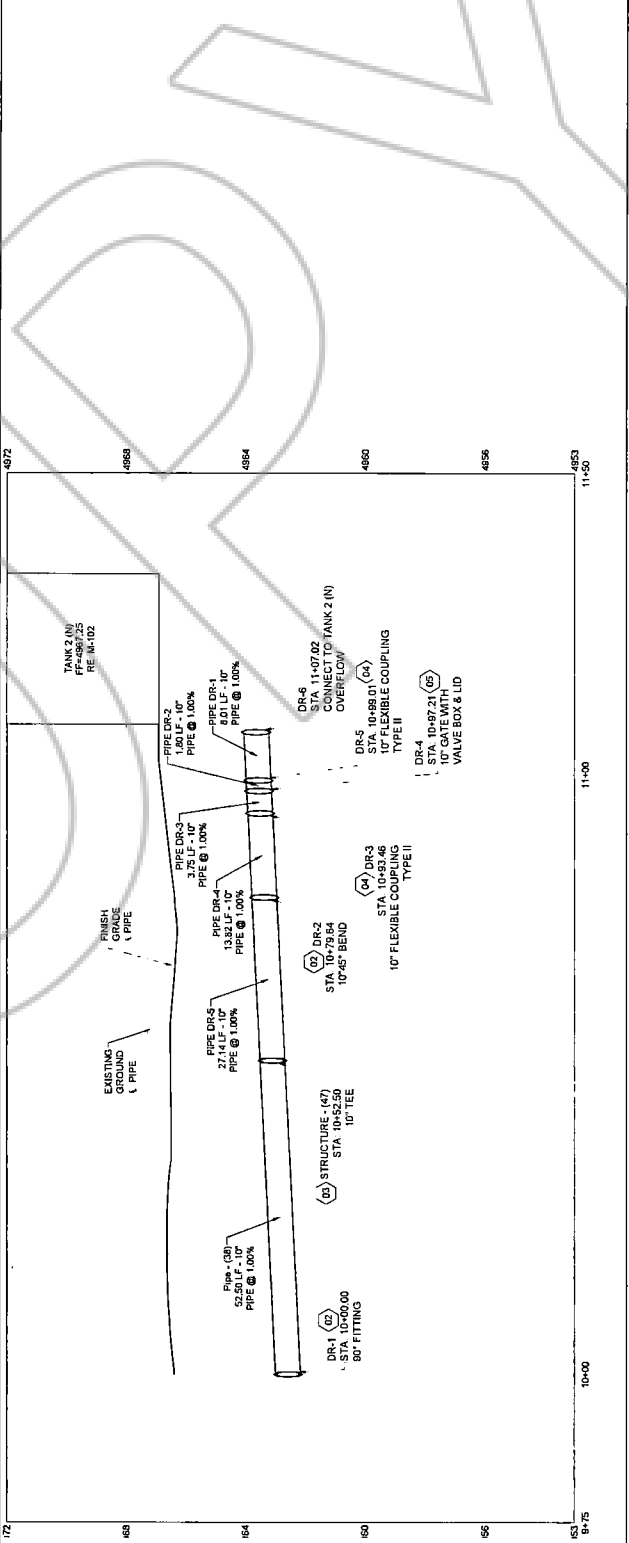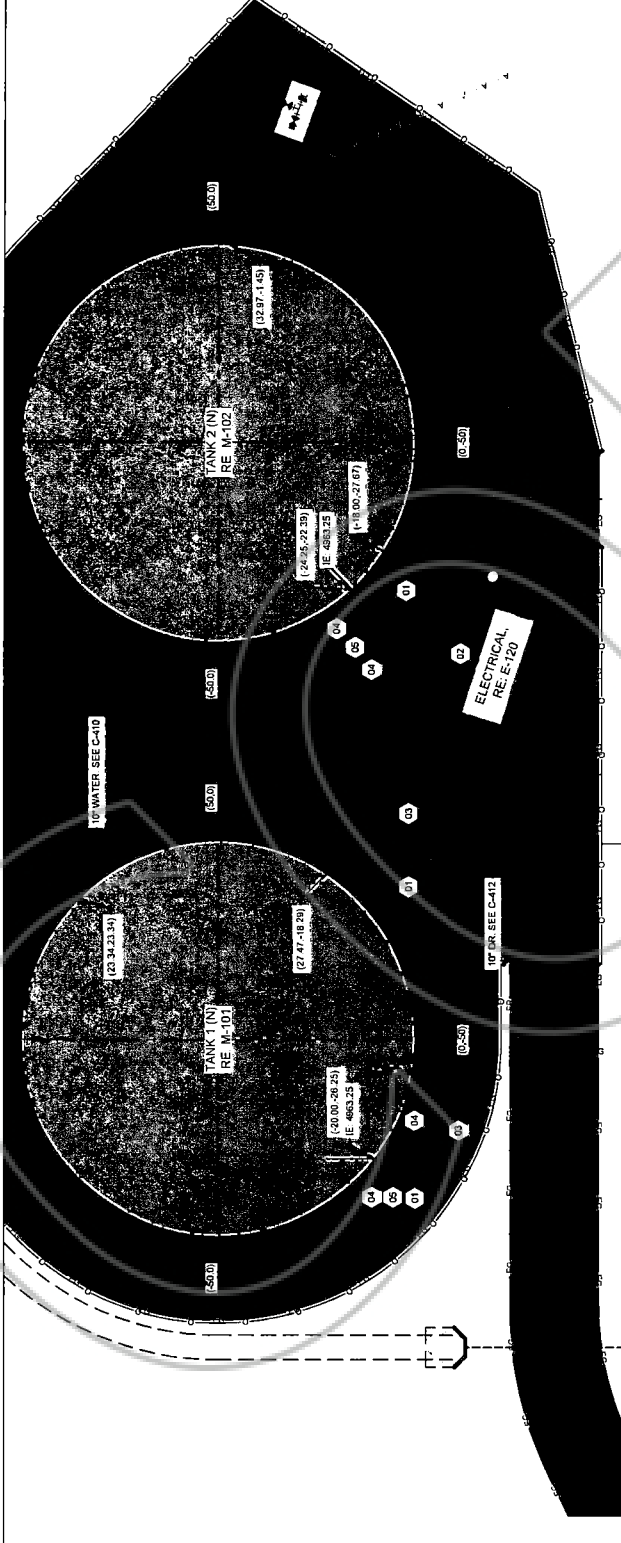


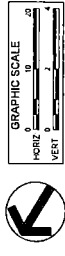


GENERAL SHEET NOTES


1. PRIOR TO CONSTRUCTION CONTRACTOR TO LOCATE ALL EXISTING UTILITIES IN A NON-DESTRUCTIVE MANNER. CONTRACTOR SHALL BE RESPONSIBLE FOR ANY UTILITIES ENCOUNTERED. IT IS RECOMMENDED THAT THE CONTRACTOR HIRE A GROUND PENETRATING RADAR (GPR) OPERATOR TO VERIFY THE LOCATION AND DEPTH OF ALL UTILITIES IN THESE AREAS PRIOR TO MATERIAL EXCAVATION IN THESE AREAS.
2. CONTRACTOR TO VERIFY AND LOCATE ALL PIPE CONNECTIONS TO VERIFY PIPE LENGTHS PRIOR TO ORDERING MATERIALS.
3. AREAS DISTURBED BY CONSTRUCTION WHERE SURFACE REPAIR IS NOT INDICATED SHALL BE REPAIRED TO ORIGINAL FINISH TO BETTER CONDITION PRIOR TO CONSTRUCTION.
4. ASBURNES UTILITY (U) SHALL BE MAINTAINED UNLESS IMPACTED BY NEW CONSTRUCTION. CONTRACTOR TO PLUG ENDS OF EXPOSED PIPING.
5. PROVIDE MECHANICALLY RESTRAINED JOINTS UNLESS OTHERWISE SPECIFIED. MAKE ANY CHANGE IN DIRECTION, RE-SPECIFICATIONS.
6. HORIZONTAL & VERTICAL LOCATION OF EXISTING UTILITIES ARE APPROXIMATE. SEE GENERAL NOTE #1.
7. CONTRACTOR TO FURNISH ALL MATERIALS UNLESS NOTED OTHERWISE.

SHEET KEYNOTES

- 01 INSTALL PIPE - 10" DR
- 02 INSTALL FITTINGS - 10" TEE RE DOUGLAS COUNTY STD B12
- 03 DISCHARGE INTO OVERFLOW BASIN
- 04 OVERFLOW BASIN
- 05 EMERGENCY SPILLWAY RE 300C-5XX

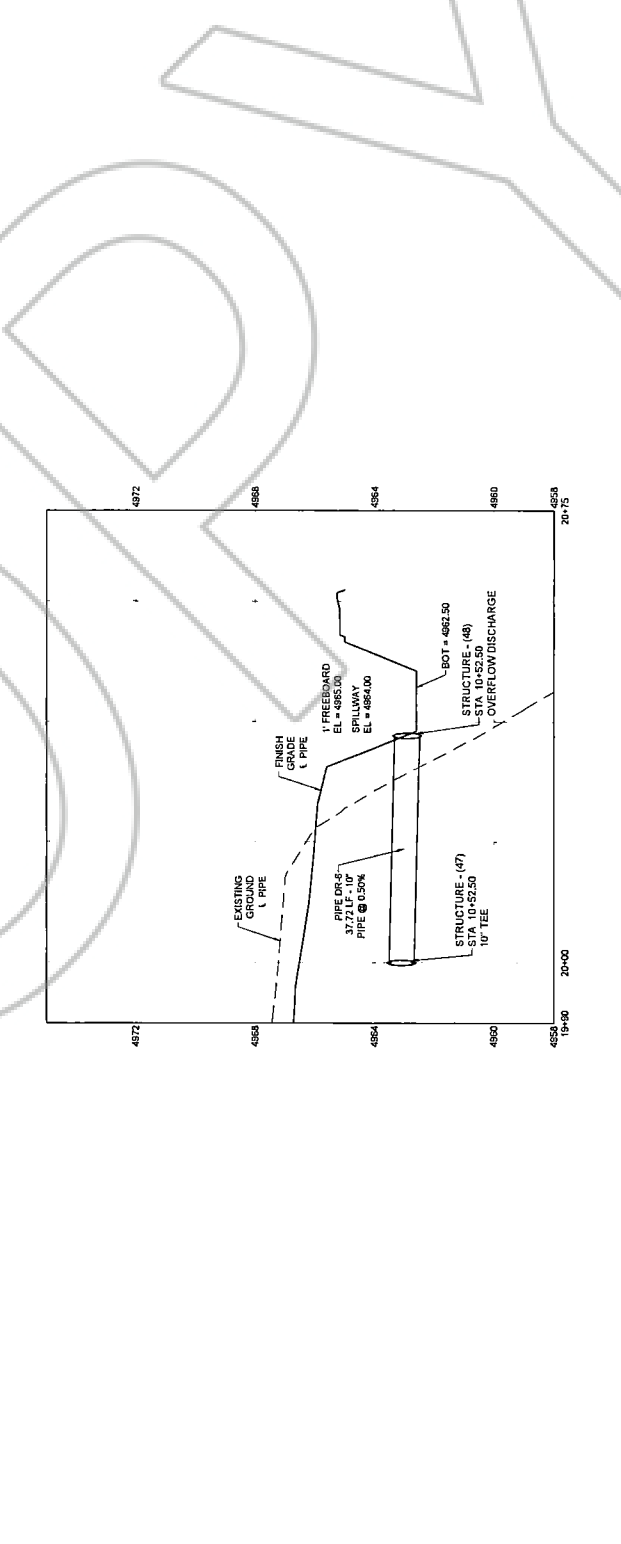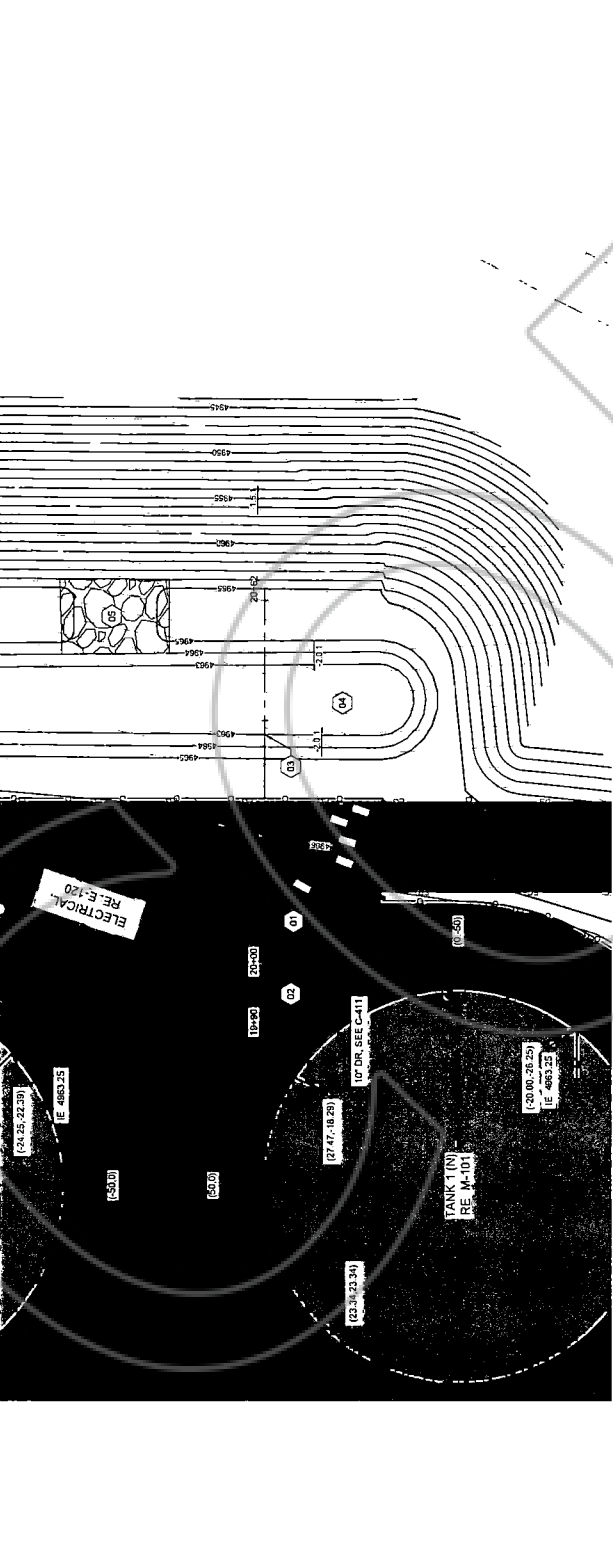


DRAFT

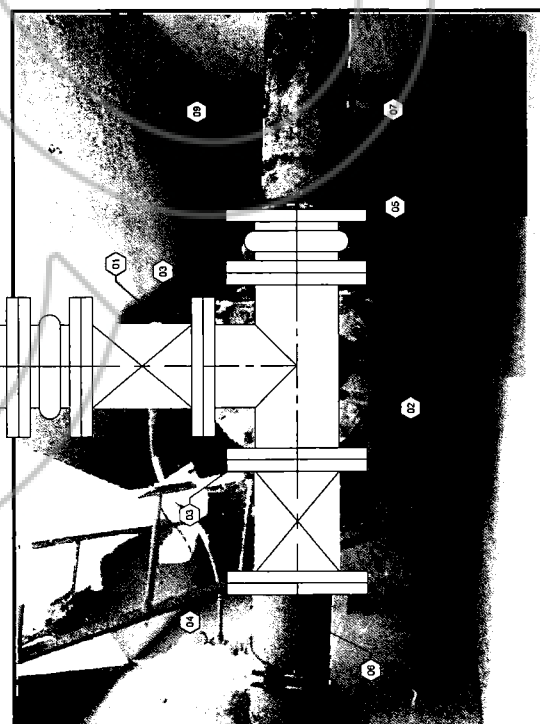

- 01 SALVAGE CJA VALVE & RETURN TO OWNER
- 02 INSTALL FITTING - 10" TEE
- 03 INSTALL VALVE - 10" GATE
- 04 INSTALL FITTING - 10" BUNG FLANGE
- 05 REMOVE FLANGE COUPLING & INSTALL RESTRAINED FLANGE ADAPTER
- 06 REMOVE EXISTING PIPE, RE C-209
- 07 CORE DR HAMMER THROUGH EXISTING SLUGS TO CREATE A MINIMUM OF 2' OF DRAIN PILES
- 08 RE C-110 FOR CONTINUATION OF WATER LINE
- 09 RETAIN & PROTECT EXISTING PIPE


NOTES:
 1. GRADE BEHIND VAULT AND WALLS TO TOP OF CLSM. FILL BACKFILL AND SURFACE ABOVE VAULT IN ACCORDANCE WITH SPECIFICATIONS.
 2. RE C-209 FOR TEMPORARY APURTANCES.

A1 VAULT MODIFICATIONS
 11.12

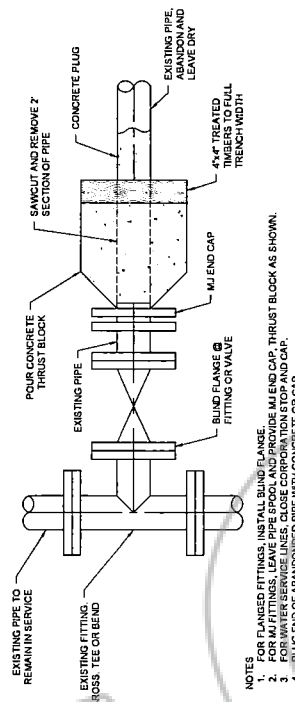


NOTES
 FOR FLANGED FITTINGS, INSTALL BLIND FLANGE.
 1. FOR ALL FITTINGS, LEAVE PIPE SPOOL AND PROVIDE MJ END CAP, THURST BLOCK AS SHOWN.
 2. FOR ALL FITTINGS, LEAVE PIPE SPOOL AND PROVIDE MJ END CAP, THURST BLOCK AS SHOWN.
 3. PLUG END OF ABANDONED PIPE WITH CONCRETE OR CAP.
 4. PLUG END OF ABANDONED PIPE WITH CONCRETE OR CAP.

C3 CUT, PLUG AND ABANDON EXISTING WATER LINES
 3' x 1'-0"

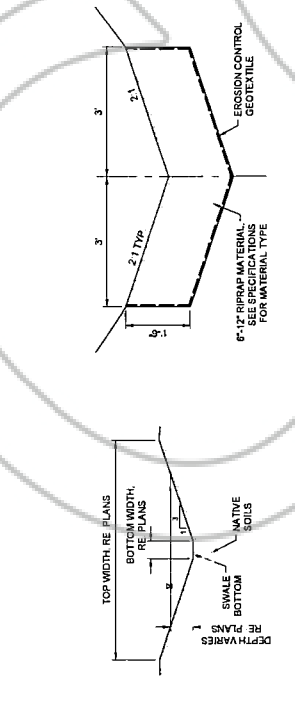


C1 OUTFALL DRAINAGE DITCH
 3/8" x 1'-0"

C2 PERIMETER DRAINAGE DITCH
 N.I.S.

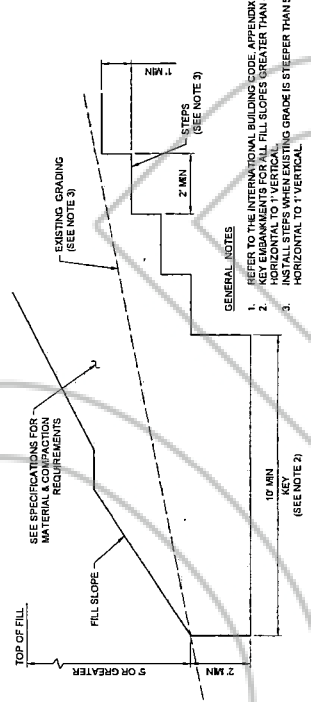


GENERAL NOTES
 1. REFER TO THE INTERNATIONAL BUILDING CODE APPENDIX J FOR ALL FOUNDATION DETAILS.
 2. HORIZONTAL TO 1" VERTICAL FILL SLOPES GREATER THAN 4:1.
 3. INSTALL STEPS WHEN EXISTING GRADE IS STEEPER THAN 5' HORIZONTAL TO 1" VERTICAL.

B3 FILL SLOPE FOUNDATION
 10' x 1'-0"

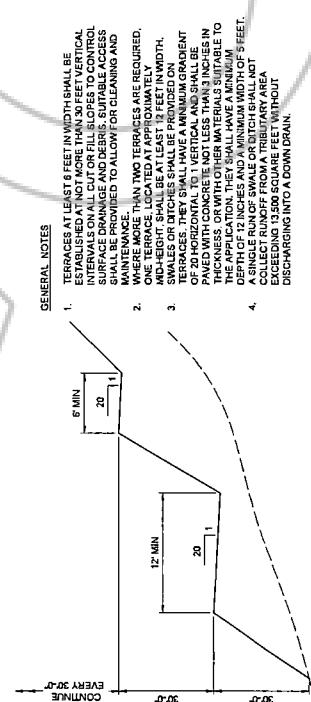


B1 TERRACING
 10' x 1'-0"

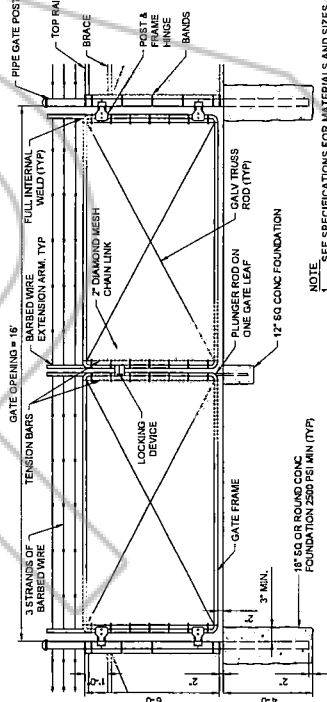


NOTE
 1. SEE SPECIFICATIONS FOR MATERIALS AND SIZES.
 2. SEE FENCE DETAIL FOR BRACING AT GATE.





A3 GATE-CHAIN LINK DOUBLE SWING WITH 3 STRANDS
 4' x 1'-0"

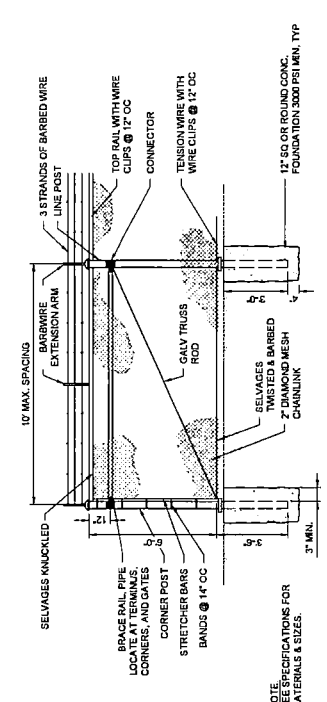

A1 FENCE-CHAIN LINK WITH 3 STRAND
 4' x 1'-0"

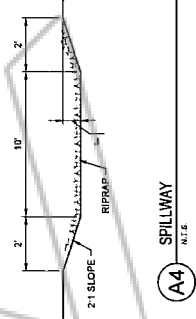

A4 SPILLWAY
 N.I.S.

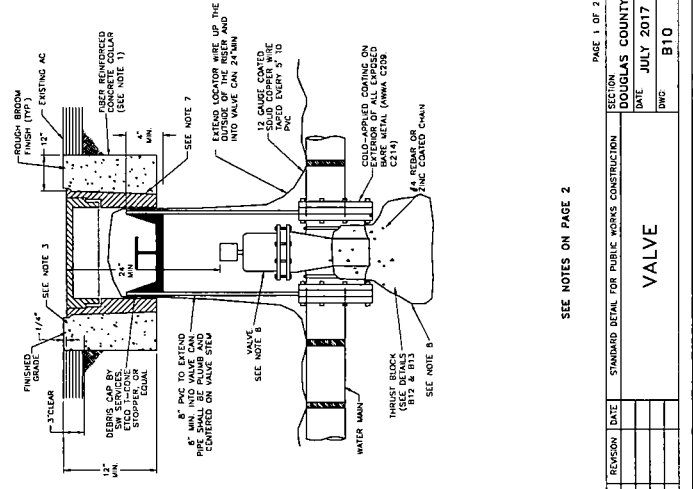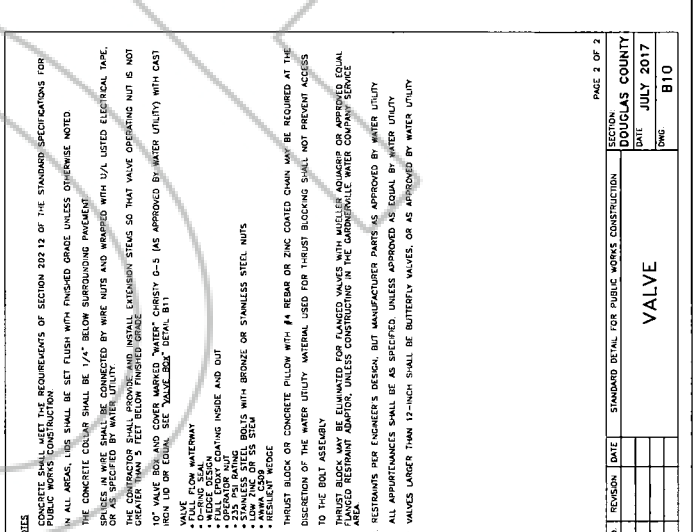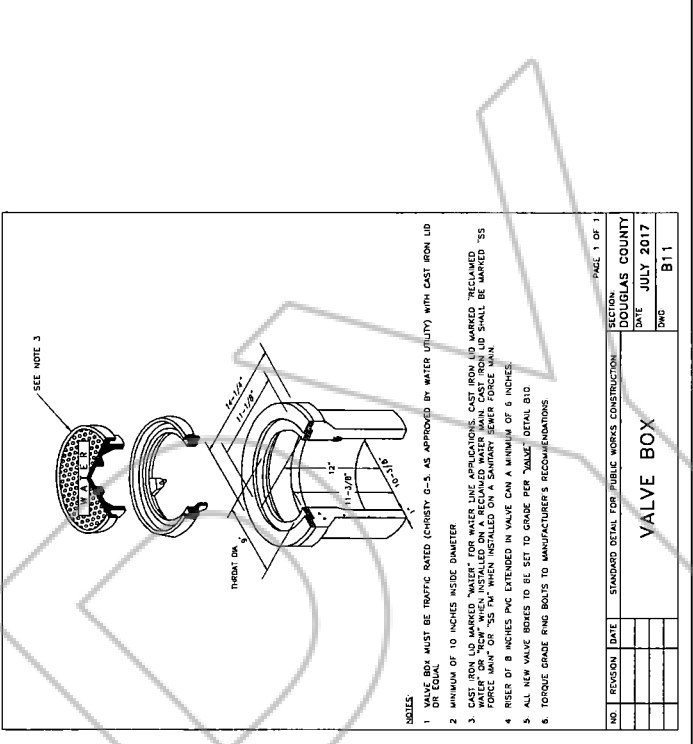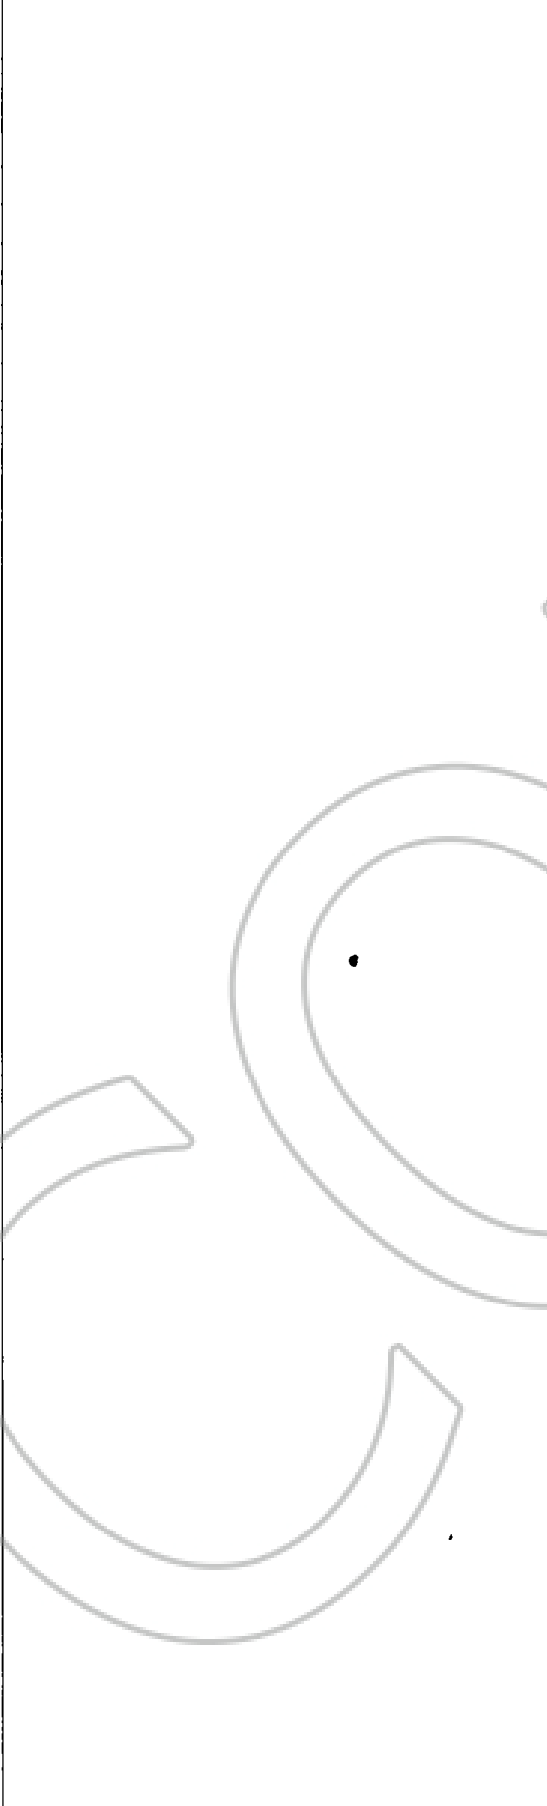

NO. REVISION DATE STANDARD DETAIL FOR PUBLIC WORKS CONSTRUCTION
 SECTION DOUGLAS COUNTY
 DATE JULY 2017
 DWG B11

NO. REVISION DATE STANDARD DETAIL FOR PUBLIC WORKS CONSTRUCTION
 SECTION DOUGLAS COUNTY
 DATE JULY 2017
 DWG B10

NO. REVISION DATE STANDARD DETAIL FOR PUBLIC WORKS CONSTRUCTION
 SECTION DOUGLAS COUNTY
 DATE JULY 2017
 DWG B10



for Design
Review
Not For
Construction

NO REVISIONS
DATE
The documents are the property of Keller Associates, Inc. and shall not be copied or reproduced without authorization of Keller Associates, Inc.



DOUGLAS COUNTY, NEVADA


MOUNTAIN VIEW WATER TANK REPLACEMENT
DOUGLAS COUNTY DETAILS (3 OF 3)

DRAWN BY: JWC
CHECKED BY: JWC
PROJECT NO: 223125
SHEET NO: C-513



NOTES

1. ALL REQUIREMENTS OF THE STORM DRAIN UTILITY ORDINANCE MUST BE MET.
2. CLASS A AND CLASS E BACKFILL AND BEDDING MATERIAL SHALL CONFORM TO SECTION 200.02 OF THE STANDARD SPECIFICATIONS FOR PUBLIC WORKS CONSTRUCTION. MATERIALS SHALL BE PROPERLY COMPACTED IN CONFORMANCE WITH SECTION 200.02 OF THE STANDARD SPECIFICATIONS FOR PUBLIC WORKS CONSTRUCTION.
3. PLACE WARNING TAPE 1-FOOT ABOVE STORM DRAIN PIPE. WARNING TAPE SHALL READ "DANGER, STORM DRAIN".
4. CLASS A BACKFILL IS BEDDING MATERIAL PER ORANGE BOOK 200.03.02. COMPACT OR CONSOLIDATE TO PROVIDE PROPER SUPPORT OF PIPE.
5. UTILIZE WATER STOP DETAIL FOR WET TRENCHES.

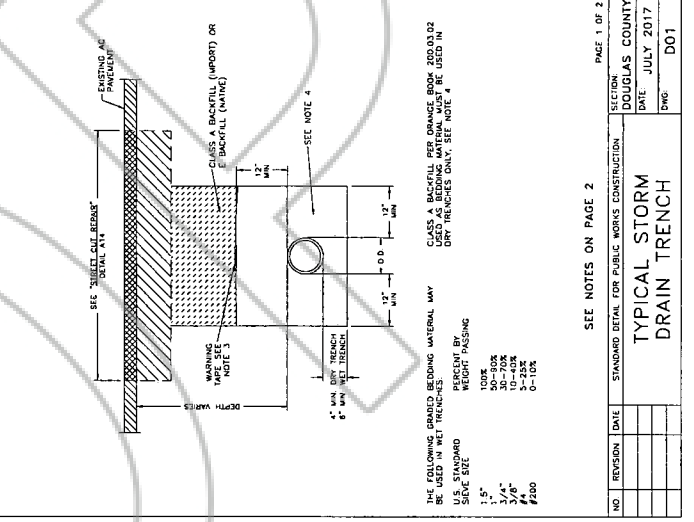

THE FOLLOWING GRADED BEDDING MATERIAL MAY BE USED IN WET TRENCHES:

U.S. STANDARD SIZE	PERCENT BY WEIGHT PASSING
1"	100%
3/4"	70%
3/8"	25%
#100	0-10%

CLASS A BACKFILL PER ORANGE BOOK 200.03.02 USED AS BEDDING MATERIAL MUST BE USED IN WET TRENCHES. SEE NOTE 4.

NOTES

1. CONCRETE FOR THRUST BLOCKS SHALL CONFORM TO SECTION 337.10 OF THE STANDARD SPECIFICATIONS FOR PUBLIC WORKS CONSTRUCTION AND SHALL HAVE A MINIMUM COMPRESSIVE STRENGTH OF 4000 PSI AT 28 DAYS.
2. JOINTS AND FACES OF PLACES SHALL BE VERY CLEAN OF CONCRETE.
3. ANOMALOUS DIMENSIONS AND A FACTOR OF SAFETY OF 1.5 IN ALL INSTALLATIONS DURING DIFFERENT TEST PRESSURES AND/OR SOIL TYPES SHALL BE ADJUSTED BY THE DESIGN ENGINEER.
4. ALL CONCRETE SHALL BE POLYMERIZED UNION POLYMERIZED (9 W/30 W/30).

Type of Filling	90° Band	45° Band	11,25° or 22.5° Band
Typical Installation			
Typical Installation			

Minimum Thrust Block Bearing Area - Square Feet (1.44)	90° Band	45° Band	11,25° or 22.5° Band
4"	5	1	2
6"	6	3	4
8"	13	5	6
10"	18	7	9
12"	25	10	13
14"	32	13	17
16"	40	17	23

SEE NOTES ON PAGE 2

PAGE 2 OF 2
SECTION: DOUGLAS COUNTY
DATE: JULY 2017
DWG: D01

PAGE 1 OF 2
SECTION: DOUGLAS COUNTY
DATE: JULY 2017
DWG: D01

SEE NOTES ON PAGE 2
SECTION: DOUGLAS COUNTY
DATE: JULY 2017
DWG: D01

PAGE 1 OF 1
SECTION: DOUGLAS COUNTY
DATE: JULY 2017
DWG: B12

THRUST BLOCKS

50% Design
 Review
 Not For
 Construction

NO.	REVISIONS	DATE

DOWN	— CHECK	BC
VERIFY SCALE. Scale is based on 22'x34" print.		
PROJECT NO.	1-11210000	
PAGE	223125	
SHEET NO.	E-120	



GENERAL SHEET NOTES


- ELECTRICAL WORK SHALL BE PERFORMED IN ACCORDANCE WITH THE 2017 NATIONAL ELECTRICAL CODE AND ANY OTHER STATE OR LOCAL CODE.
- ALL CONDUIT RUNS ARE TO BE INSTALLED AS SHOWN ON THE DRAWING. FINAL ROUTING SHALL BE DETERMINED BY THE ELECTRICAL CONTRACTOR AND APPROVED BY THE OWNER.
- ALL ELECTRICAL EQUIPMENT AND WIRING SHALL BE WEATHERPROOF.
- ALL UNDERGROUND CABLE RUNS SHALL BE INSTALLED IN CONDUIT.
- ALL ELECTRICAL CONDUITS SHALL BE MARKED WITH RED PLASTIC MARKING TAPE INSTALLED IN THE TRENCH ONE FOOT BELOW SURFACE. RE E-501.

SHEET KEYNOTES

- 01 RELOCATE EXISTING ANTENNA TO NEW POSITION.
- 02 INSTALL INVERTER AND CONTROL CONDUIT TO TANK 1 AND TANK 2.
- 03 EXISTING PANEL SHIELD.


EQUIPMENT KEYNOTES

- ANT-1 RELOCATED ANTENNA
- ICCP-1 TANK 1 IMPRESSED CURRENT CATHODIC PROTECTION SYSTEM
- ICCP-2 TANK 2 IMPRESSED CURRENT CATHODIC PROTECTION SYSTEM
- PNL-1 EXISTING PANEL
 - SEC.1 - INVERTER AND CHARGE CONTROLLER
 - SEC.2 - BATTERIES
 - SEC.3 - SCADA CONTROLS

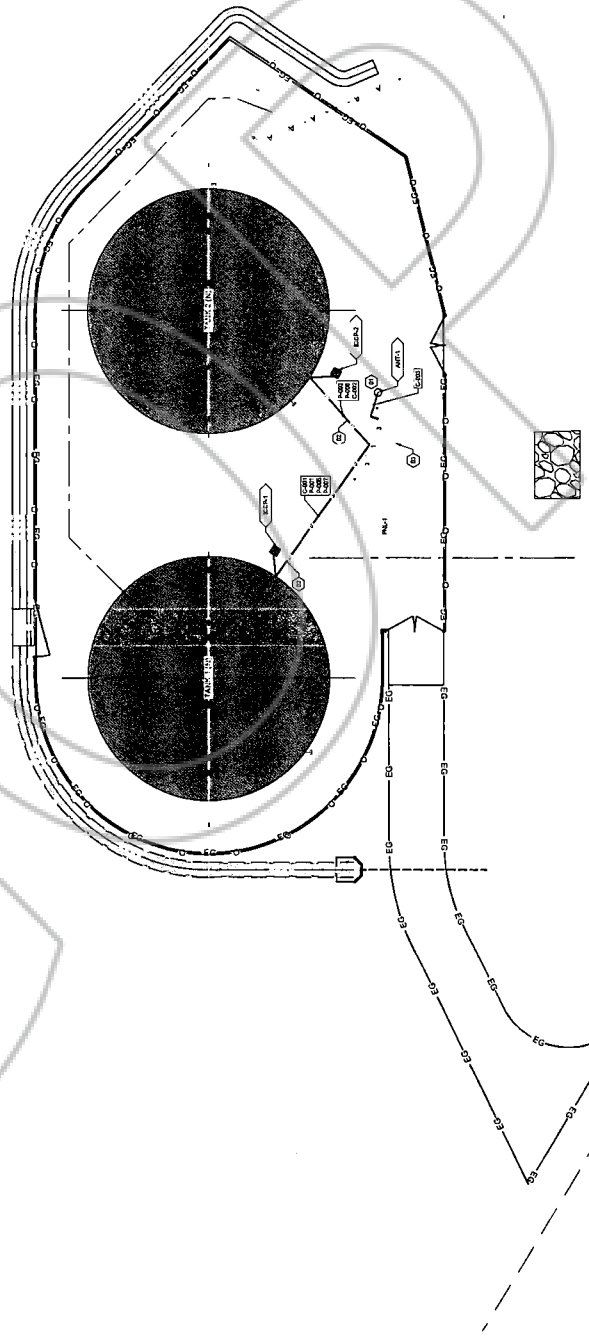

90% Design
 Review
 Not For
 Construction

NO.	DATE	REVISIONS

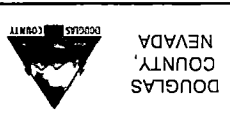

TANK 1 - STRUCTURAL PLAN
MOUNTAIN VIEW WATER TANK REPLACEMENT


DRAWN: DAC/DCEK	PROJECT NO: 223125
VERIFY SCALE: Scales based on 22"x34" print.	PAGE: 1-1/2 sheets
PROJECT NO: 223125	SHEET NO: S-101

GENERAL SHEET NOTES

- SEE SPECIFICATIONS FOR COMPLETE REQUIREMENTS. TANK SHOWN IS FOR REPRESENTATION ONLY.
- TANK CONTRACTOR TO PROVIDE FULL TANK FOOTING AND FOUNDATION DESIGN, AND SHOP DRAWINGS PRIOR TO CONSTRUCTION.
- ALL PIPING ABOVE GRADE TO BE STAINLESS STEEL 304.
- SEE C-115 FOR OVERALL LAYOUT AND STRUCTURE COORDINATES.

SHEET KEYNOTES

01	ACCESS LADDER
02	LIQUID LEVEL INDICATOR
03	GRUBBER MIXER PORT
04	24" TANK ROOF VENT, RE. B26-S01
05	10" FLOOR DRAIN
06	10" OVERFLOW OUTLET
07	30" SHELL MANHOLE, RE. A6IS-S02
08	10" TANK INLET, RE. B11S-S02
09	SAMPLE TAP
10	ROOF ANTI SLIP COATING, RE. B26S-S02
11	42" x 42" ROOF HATCH, RE. A11S-S01 AND A11S-S02
12	HANDRAIL, RE. A1, A3IS-S02
13	ANODE SUPPORTS, RE. A11S-S03
14	STAINLESS STEEL JUNCTION BOX, RE. A11S-S03
15	INTERIOR LADDER
18	PERIMETER ROOF VENT

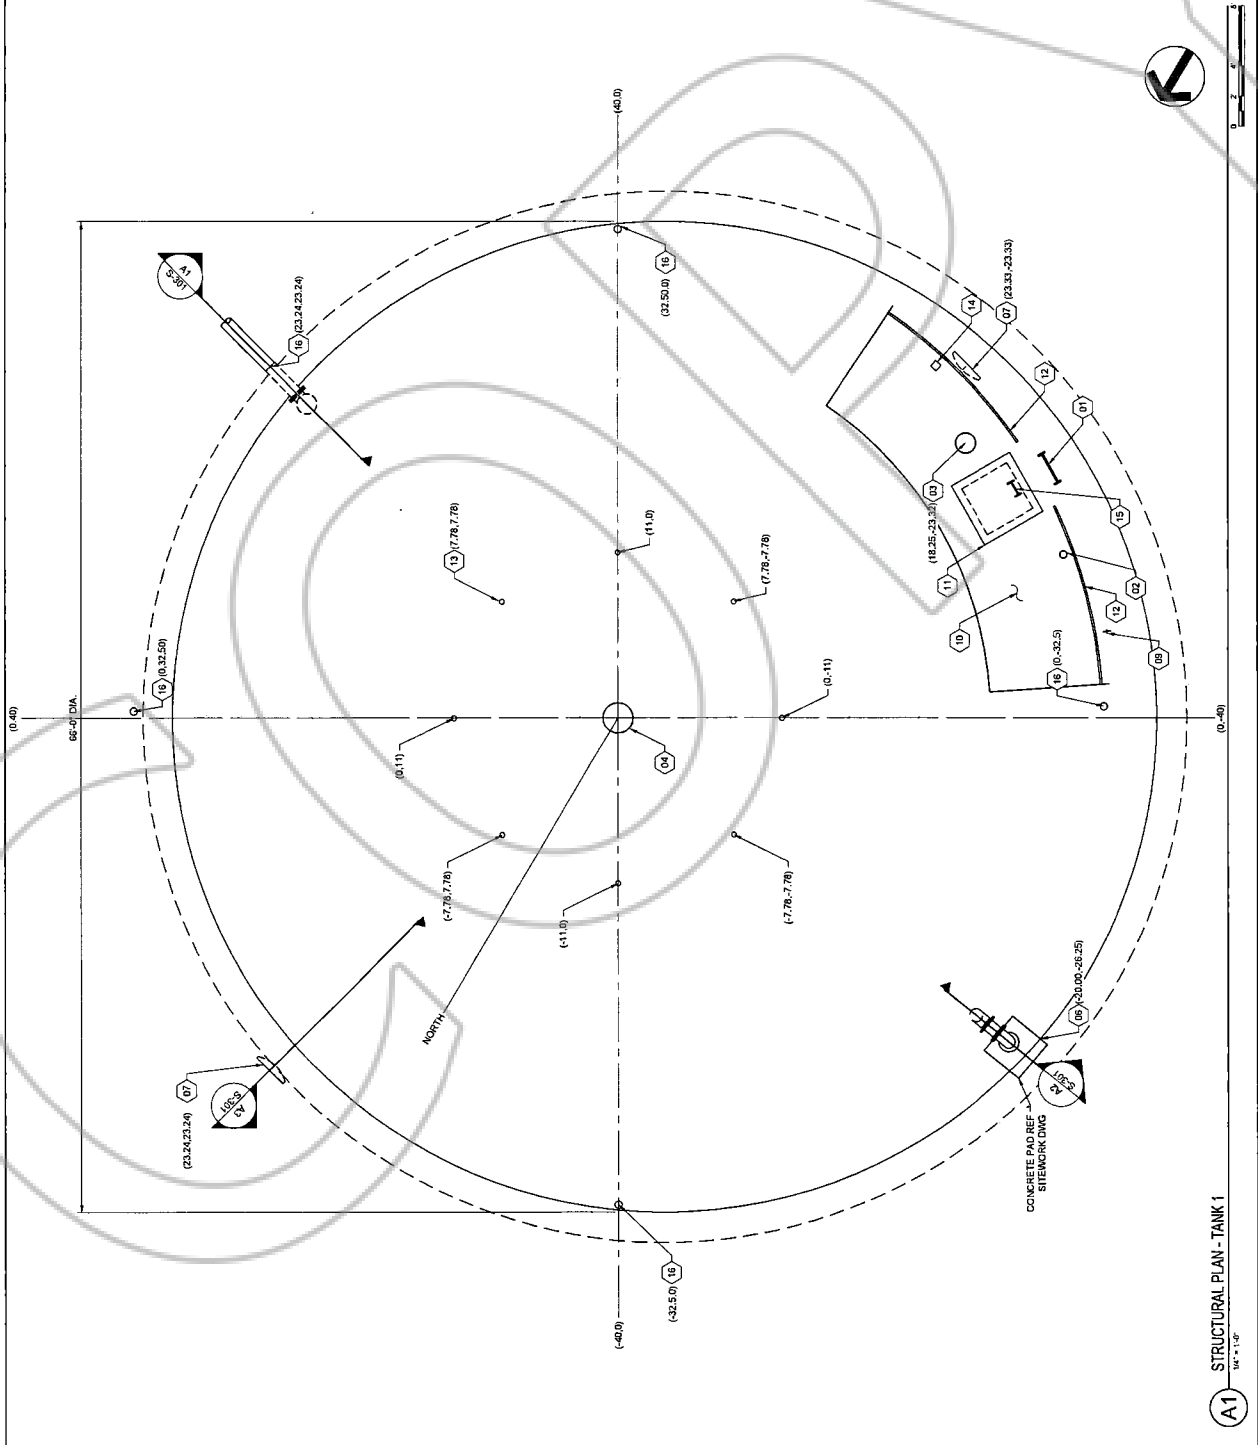

A1 STRUCTURAL PLAN - TANK 1
 10'-1" = 1"

GENERAL SHEET NOTES

1. SEE SPECIFICATIONS FOR COMPLETE REQUIREMENTS, TANK SHOWN IS FOR REPRESENTATION ONLY
2. TANK CONTRACTOR TO PROVIDE FULL TANK REBAR AND FOUNDATION DESIGN, AND SHOP DRAWINGS PRIOR TO CONSTRUCTION

KELLER
 1255 S. HIGHLAND AVENUE
 SUITE 100
 MESA, AZ 85204
 480.942.2222

90% Design
 Review
 Not For
 Construction


NO.	REVISIONS	DATE



DOUGLAS
 COUNTY,
 NEVADA

MOUNTAIN VIEW WATER TANK
 REPLACEMENT
 TANK 1 - STRUCTURAL SECTION

DRAWN: DAC/CHECK: DRK
 VERIFY SCALE: Scale is based on 22"x34" print.
 PROJECT NO: 223125
 SHEET NO: S-301

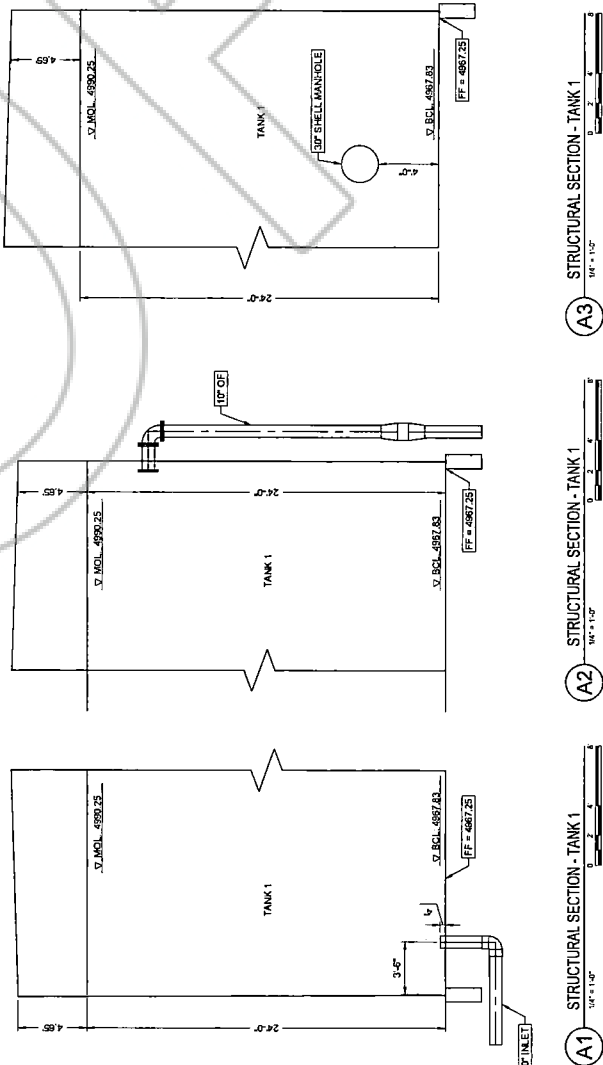



96 Design
Review
Not For
Construction

NO. REVISIONS
DATE
The documents are part of the work in which this design
was prepared and shall not be copied or used in whole or in part
without the written approval of Keller Associates, Inc.



DOUGLAS
COUNTY,
NEVADA

MOUNTAIN VIEW WATER TANK
REPLACEMENT
TANK 1 - MECHANICAL PLAN


DRAWN: CSD/CHECK: --
VERIFY SCALE: Scales
Based on 22x34" prints
1:1/2 SIZES
PROJECT NO: 223125
PAGE:
SHEET NO: M-101

GENERAL SHEET NOTES

1. --
2. --
3. --

○ SHEET KEYNOTES

- 01 ACCESS LADDER, RE STRUCTURAL
- 02 LIQUID LEVEL INDICATOR, RE XX
- 03 GROSSER MIXER, RE E-XXX
- 04 24" SCREEN ROOF VENT, RE STRUCTURAL
- 05 10" FLOOR DRAIN
- 06 10" OVERFLOW OUTLET
- 08 10" TANK INLET, RE B16-S02
- 09 3"x3" CONCRETE SPLASH PAD
- 10 SAMPLE TAP

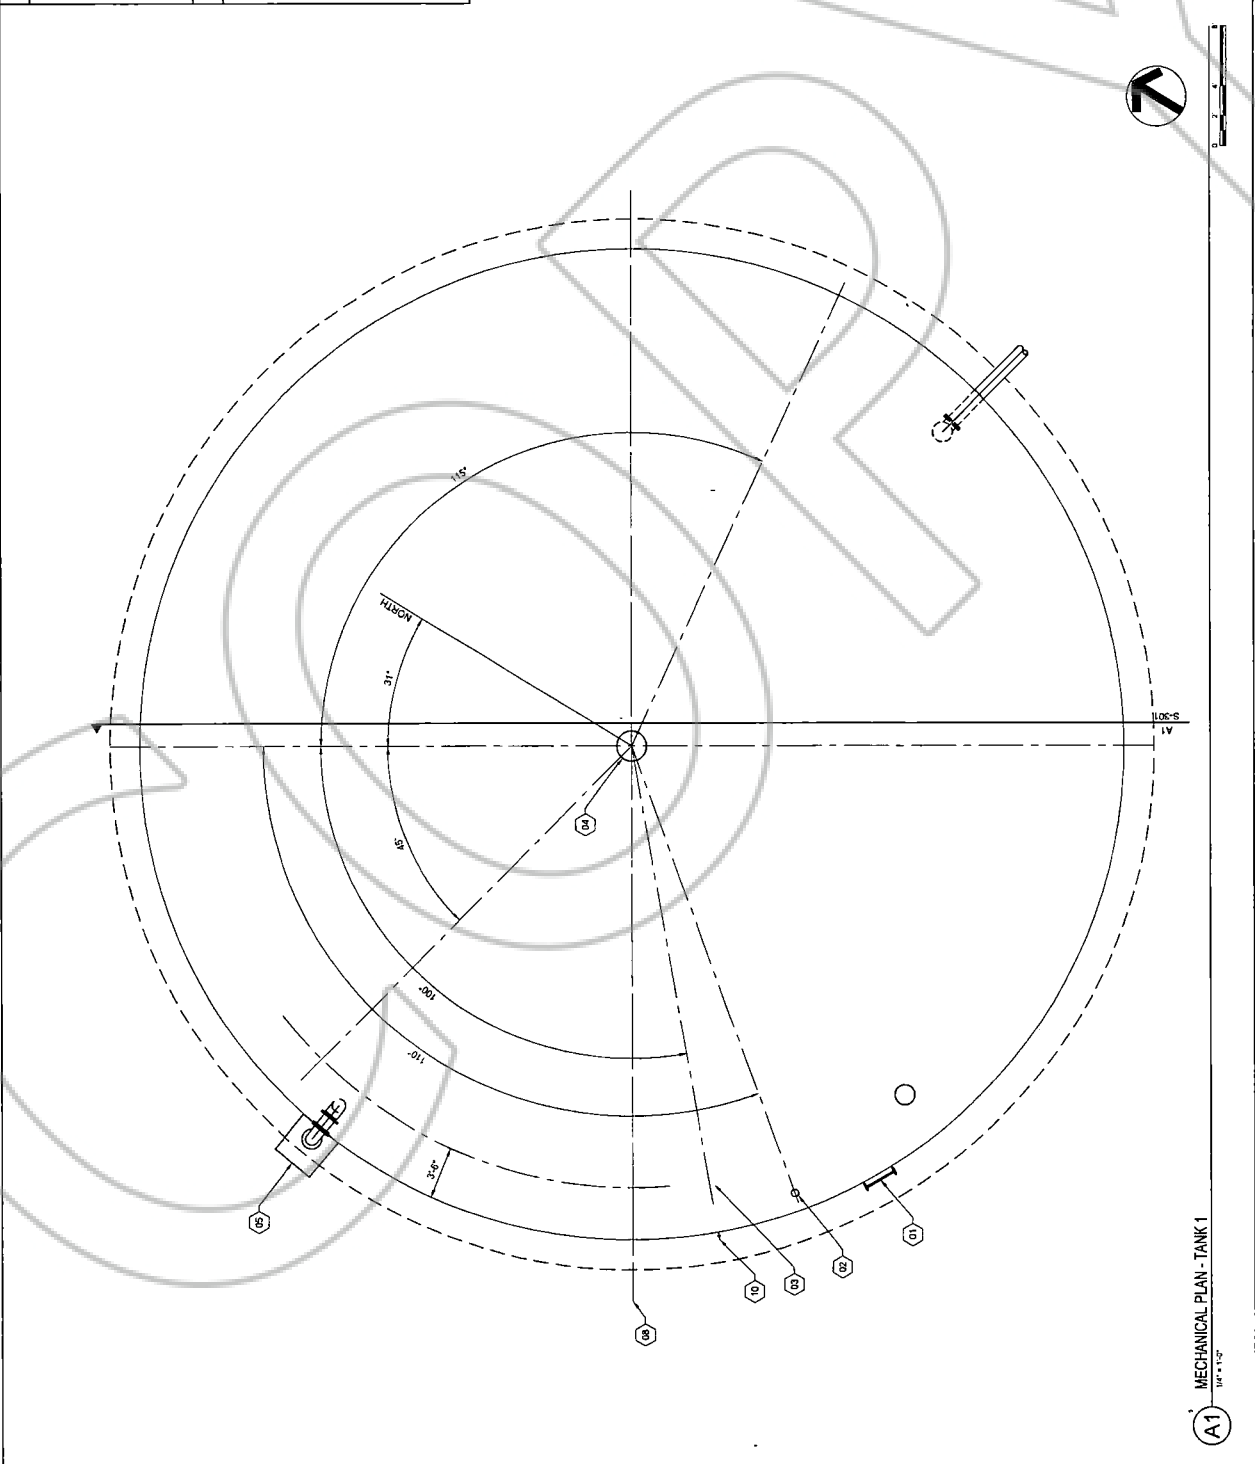

A1 MECHANICAL PLAN - TANK 1
1/8" = 1'-0"

GENERAL SHEET NOTES


1. CONTRACTOR TO PROVIDE ALL EQUIPMENT AND ACCESSORIES REQUIRED FOR A COMPLETE INSTALLATION.
2. COORDINATE WORK AND ROUGH-IN LOCATIONS WITH RELATED TRADES.
3. CONCEAL ALL RACEWAYS WITH FINISHED WALLS, CEILING AND FLOORS UNLESS OTHERWISE INDICATED.
4. ROUTE CONDUIT IN COMMON TRENCH WHENEVER POSSIBLE.
5. COORDINATE WITH SCADA INTEGRATOR.
6. RE E-402 FOR CONDUIT SCHEDULES.

SHEET KEYNOTES

- 01 ACCESS LADDER
- 02 LIQUID LEVEL INDICATOR, RE XX
- 03 GRUBBER MARKER POST AND JUNCTION BOX
- 04 ROOF HATCH PROVIDE CONNECTION TO PROXIMITY SWITCH, RE A1, A2, A3, B3, B5, B7 AND A1, A3, B2
- 05 HANDRAIL, RE A1, A3, B2
- 06 INTERIOR LADDER

EQUIPMENT KEYNOTES


- JB-1 MANUFACTURER PROVIDED TOP OF TANK 1 JUNCTION BOX
- LT-113 SUBMERSIBLE LEVEL TRANSMITTER
- LSH-112 HIGH LEVEL FLOAT SWITCH
- YS-111 ROOF HATCH PROXIMITY SWITCH

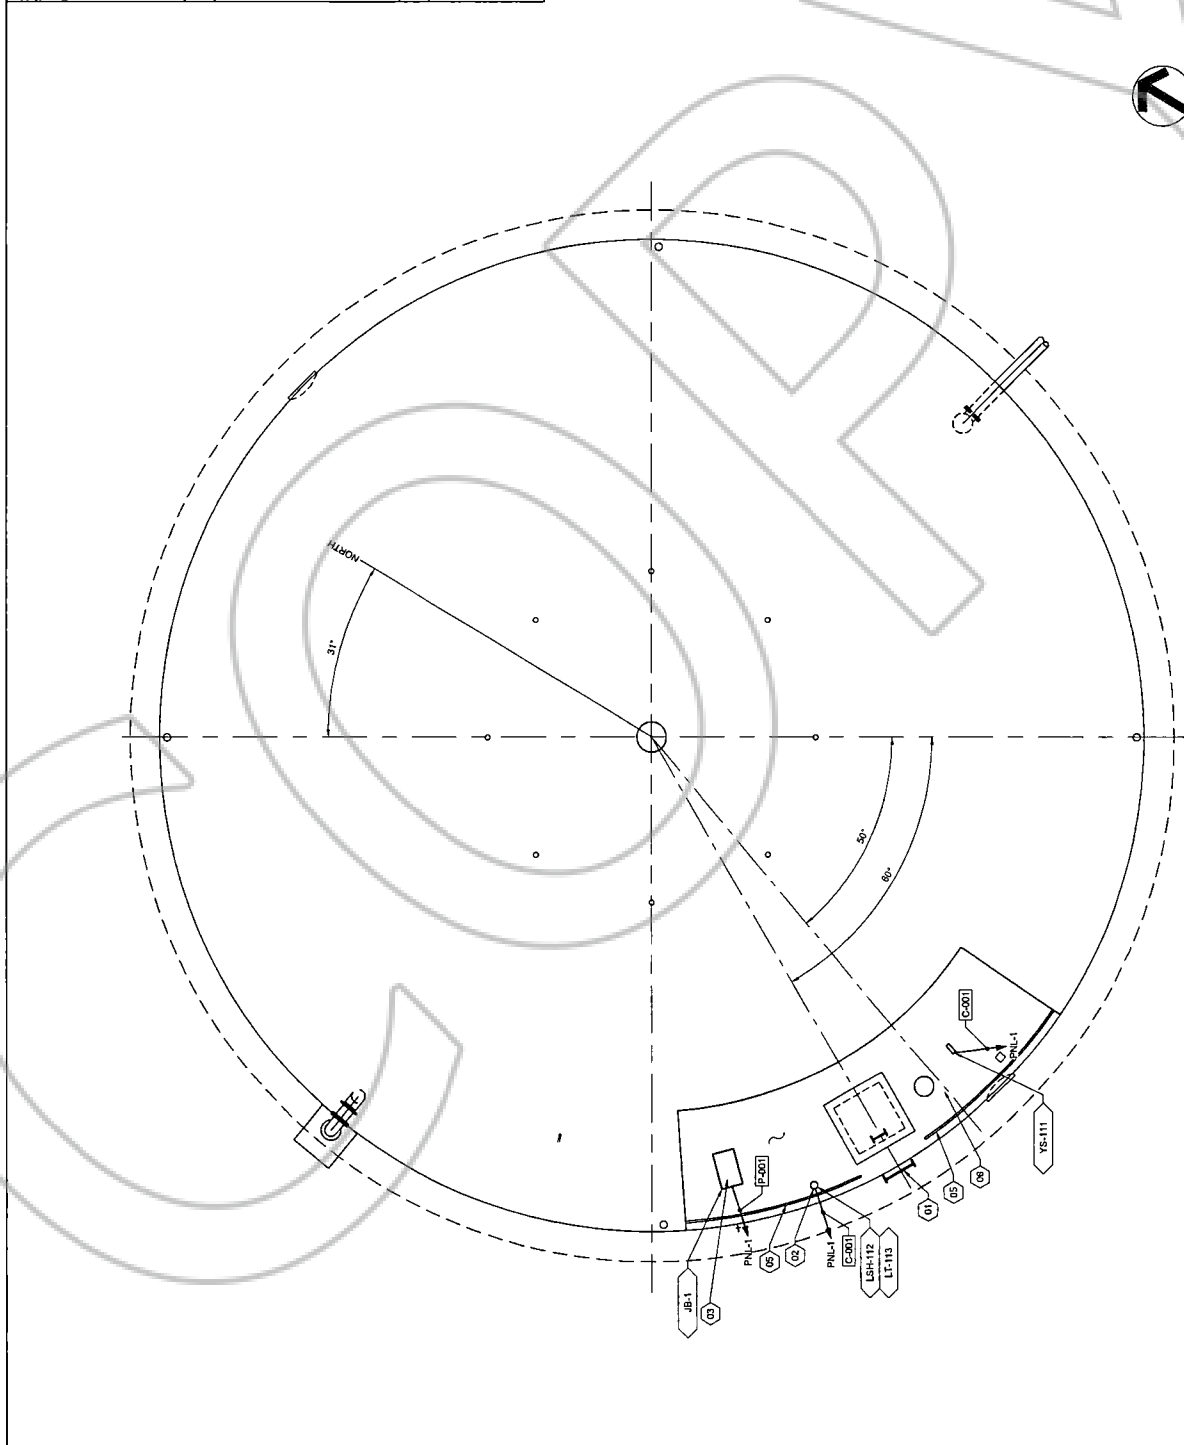

A1 ELECTRICAL AND INSTRUMENTATION PLAN - TANK 1

50. 17-1911
 Revision
 Not For
 Construction

NO REVISIONS
 This document is a part thereof in detail or design thereof as the property of Keller Associates Inc. with authorization of Keller Associates Inc.

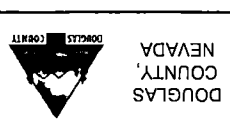

DOUGLAS COUNTY, NEVADA
 MOUNTAIN VIEW WATER TANK REPLACEMENT
 TANK 1 - ELECTRICAL AND INSTRUMENTATION PLAN

DRAWN: JACI CHECK: _____
 VERIFY SCALE: Scale based on 22"x34" prints, 1-1/2 inches
 PROJECT NO: 223125
 PAGE: _____
 SHEET NO: E-101


1/23/25 DOUGLAS COUNTY MOUNTAIN VIEW WATER TANK, DESIGN PLANS - TANK 1 ELECTRICAL INSTRUMENTATION PLAN - TANK 1 (DWG)
 LAST SAVED: 6/27/2024 4:43 AM
 PRINTED: 7/1/2024 2:35 PM

GENERAL SHEET NOTES

- SEE SPECIFICATIONS FOR COMPLETE REQUIREMENTS. TANK SHOWN IS FOR REPRESENTATION ONLY
- TANK CONTRACTOR TO PROVIDE FULL TANK FOOTING AND FOUNDATION DESIGN, AND SHOP DRAWINGS PRIOR TO CONSTRUCTION
- ALL PIPING ABOVE GRADE TO BE STAINLESS STEEL 304
- SEE CALLS FOR OVERALL LAYOUT AND STRUCTURE COORDINATES

SHEET KEYNOTES

- ACCESS LADDER
- LIQUID LEVEL INDICATOR
- GRIDDLE WALKER PORT
- 24" TANK ROOF VENT, RE. 625-501
- FLOOR DRAIN
- OVERFLOW OUTLET
- 30" SHELL MANHOLE, RE. A35-502
- 10" TANK INLET, RE. 815-502
- SAMPLE TAP
- ROOF ANTI-SLIP COATING, RE. B25-502
- 42" x 42" ROOF HATCH, RE. A15-501 AND A15-502
- HANDRAIL, RE. A1, A35-502
- ANODE SUPPORTS, RE. A15-503
- STAINLESS STEEL JUNCTION BOX, RE. A15-503
- INTERIOR LADDER
- PERIMETER ROOF VENT

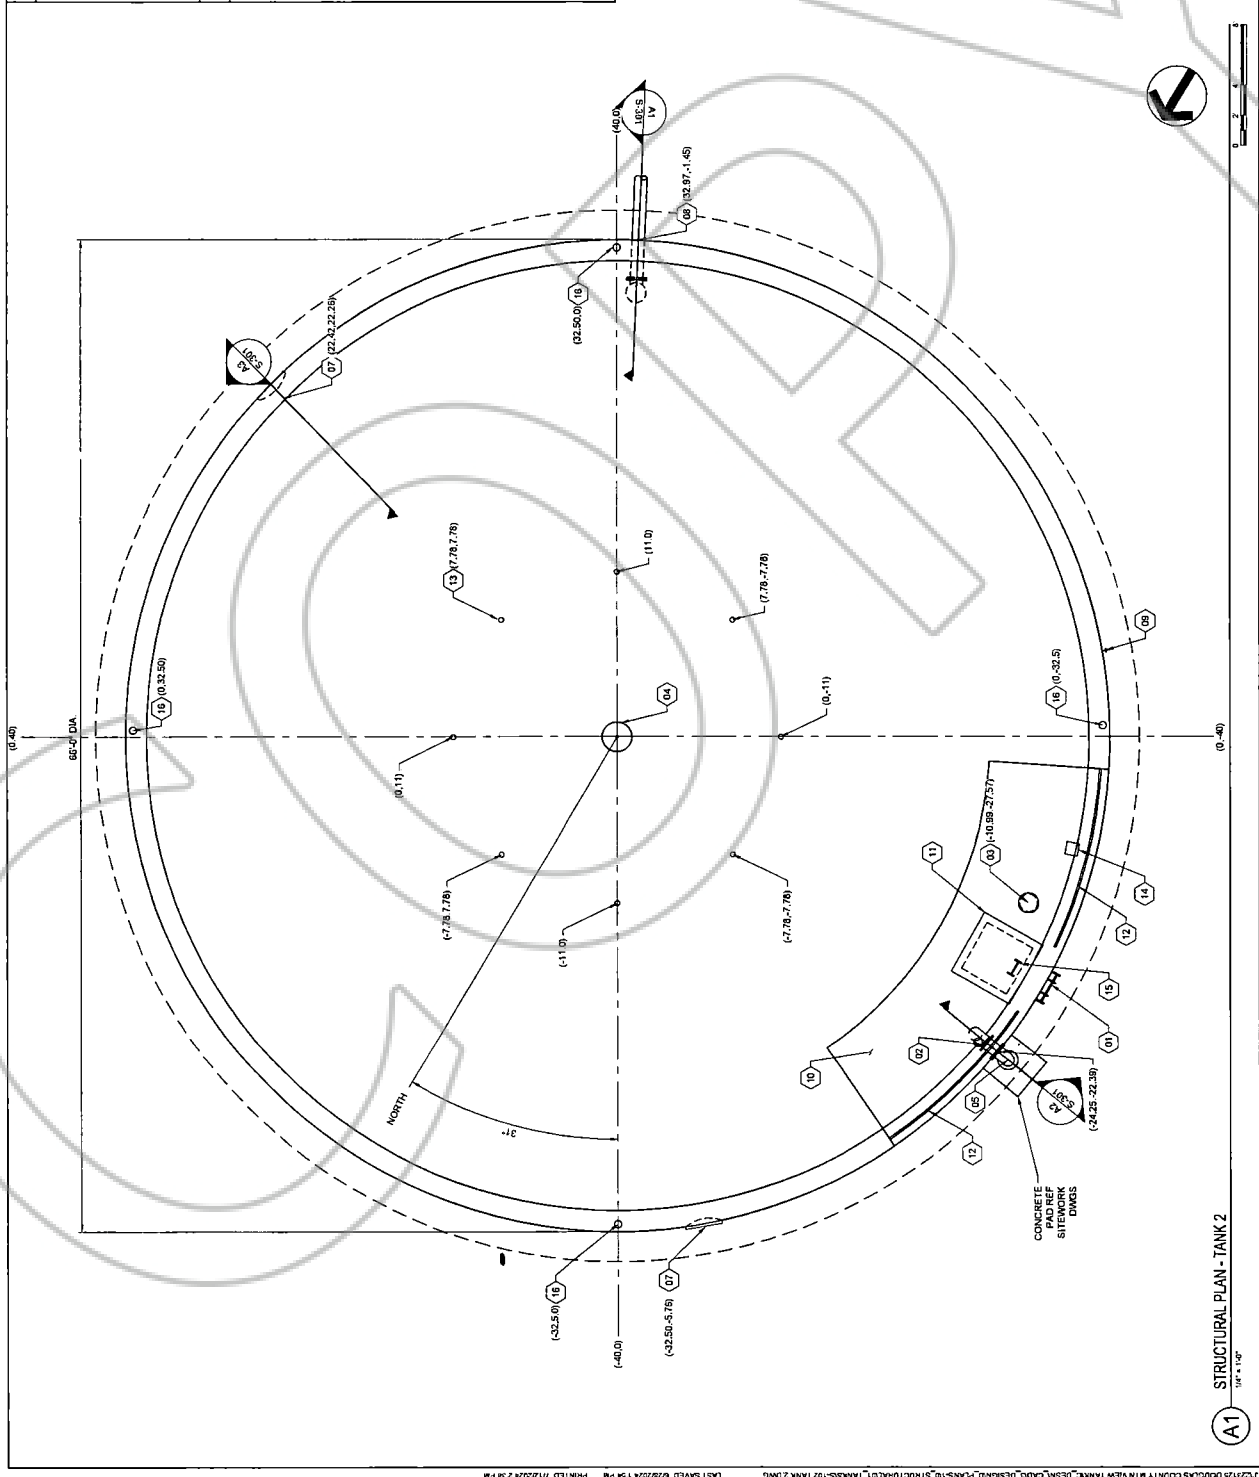

A1 STRUCTURAL PLAN - TANK 2
 1/4" = 1'-0"

GENERAL SHEET NOTES

1. SEE SPECIFICATIONS FOR COMPLETE REQUIREMENTS, TANK SHOWN IS FOR REPRESENTATION ONLY
2. TANK CONTRACTOR TO PROVIDE FULL TANK REBAR AND FOUNDATION DESIGN, AND SHOP DRAWINGS PRIOR TO CONSTRUCTION

KELLER
 15500 ALIS
 2225 W. Sahara Ave., Suite 100
 Las Vegas, NV 89102
 702.735.1100

90% Design
 Review
 Nut for
 Construction

NO. REVISIONS
 DATE

The documents are the property of Keller Associates and shall not be copied or reproduced without the written authorization of Keller Associates, Inc.

DOUGLAS COUNTY

DOUGLAS COUNTY, NEVADA


MOUNTAIN VIEW WATER TANK REPLACEMENT

TANK 2 - STRUCTURAL SECTION



DRAWING CHECK
 VERIFY SCALE. Scale based on 22"x34" prints.

PROJECT NO. 223125

SHEET NO. S-302

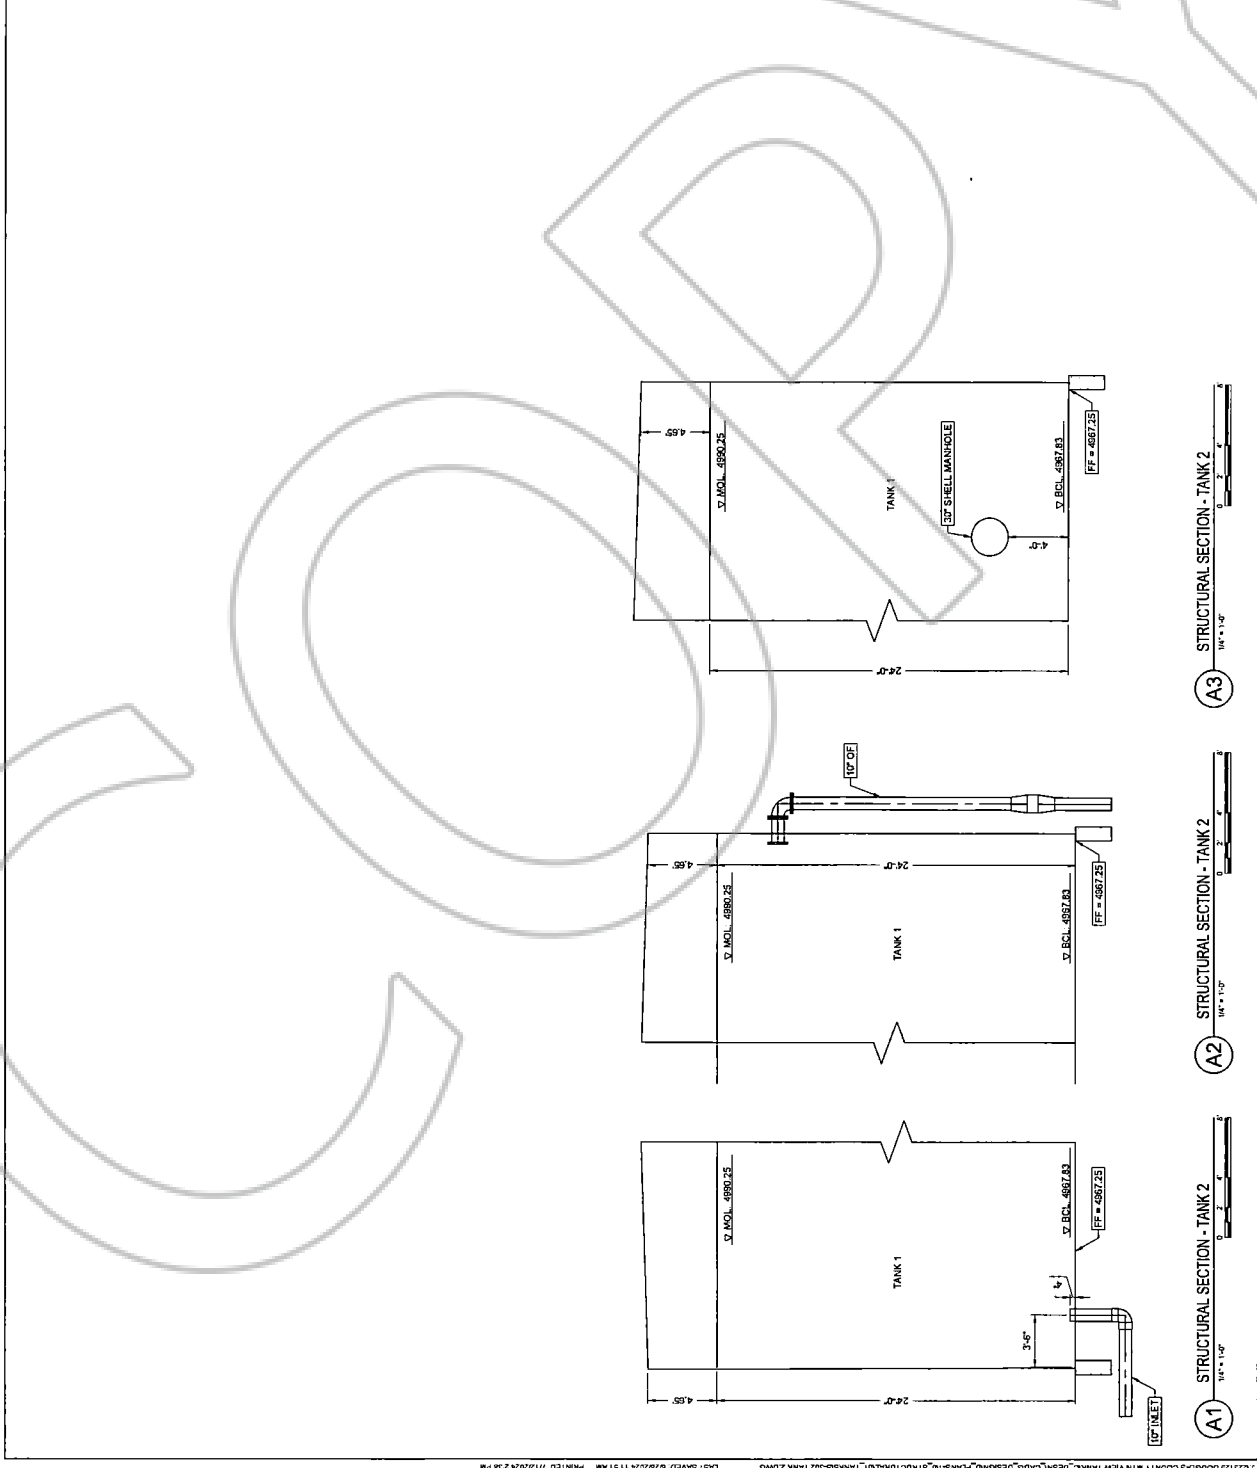

A1
MECHANICAL PLAN - TANK 2

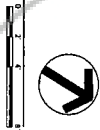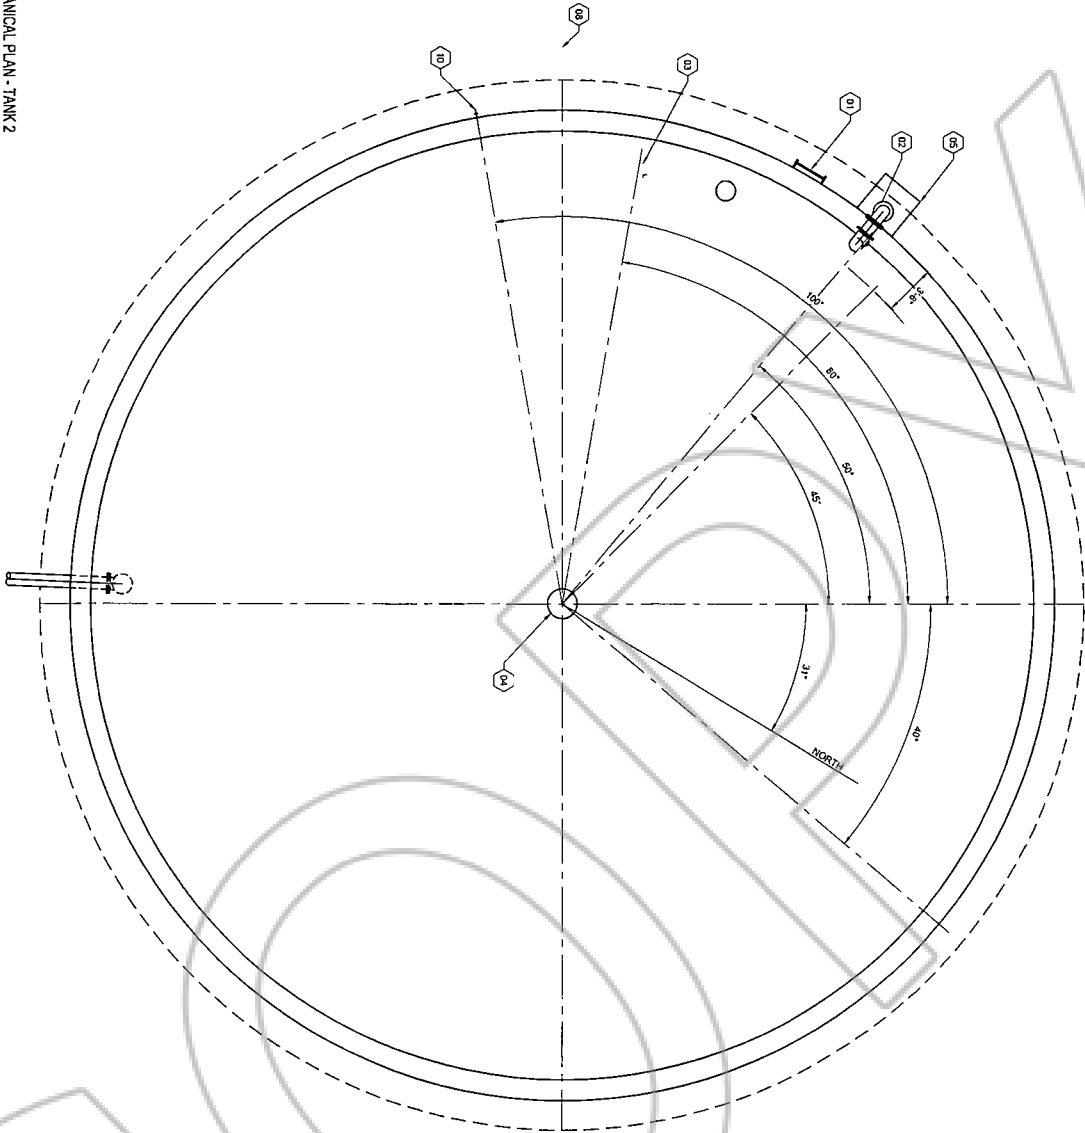

GENERAL SHEET NOTES

- 1 -
- 2 -
- 3 -

SHEET KEYNOTES

- 01 ACCESS LADDER RE STRUCTURAL
- 02 LIQUID LEVEL INDICATOR RE XX
- 03 GRIBBE WATER RE F.W.XX
- 04 24" SCREEN ROOF VENT RE B215-S01
- 05 10" FLOOR DRAIN
- 06 10" OVERFLOW OUTLET
- 07 10" TANK INLET
- 08 3x3 CONCRETE SPLASH PAD
- 09 SAMPLE TAP



50% Design
Review
Not for
Construction

NO REVISIONS DATE
This document or any part thereof in detail or design concept is the personal property of Keller Associates Inc. and shall not be copied in any form without the written authorization of Keller Associates, Inc.



DOUGLAS COUNTY, NEVADA

MOUNTAIN VIEW WATER TANK REPLACEMENT

TANK 2 - MECHANICAL PLAN

DESIGN CHECK
VERIFY SCALE
PROJECT NO. 223125
PAGE 1
SHEET NO. M-102


50 Design Review, Not For Construction

NO REVISIONS
 DATE
 WITH AUTHORIZATION OF KELLER ASSOCIATES, THE DESIGN SHALL NOT BE COPIED OR REPRODUCED IN ANY FORM WITHOUT THE WRITTEN PERMISSION OF KELLER ASSOCIATES.


GENERAL SHEET NOTES
 1 CONTRACTOR TO PROVIDE ALL EQUIPMENT AND ACCESSORIES REQUIRED FOR A COMPLETE INSTALLATION.
 2 PROVIDE NECESSARY WORK AND ROUGH-IN LOCATIONS WITH RELATED TRACES.
 3 CONCEAL ALL RACEWAYS WITHIN FINISHED WALLS, CEILINGS AND FLOORS, UNLESS OTHERWISE INDICATED.
 4 ROUTE CONDUIT IN COMMON TRENCH WHENEVER POSSIBLE.
 5 COORDINATE WITH SCADA INTEGRATOR.
 6 RE E-602 FOR CONDUIT SCHEDULES.

SHEET KEYNOTES
 01 ACCESS LADDER
 02 LIQUID LEVEL INDICATOR, RE XX
 03 GRIDBEE W/REAR PORT AND JUNCTION BOX
 04 ROOF-HATCH, PROVIDE CONNECTION TO PROXIMITY SWITCH, RE A1, A1.7A3, B3B-501 AND A1B-501
 05 HANDRAIL, RE A1, A3S-502
 06 INTERIOR LADDER


EQUIPMENT KEYNOTES
 JB-2 MANUFACTURER PROVIDED TOP OF TANK 2 JUNCTION BOX
 LT-223 SUBMERSIBLE LEVEL TRANSMITTER
 LSH-222 HIGH LEVEL FLOAT SWITCH
 YS-221 ROOF HATCH PROXIMITY SWITCH

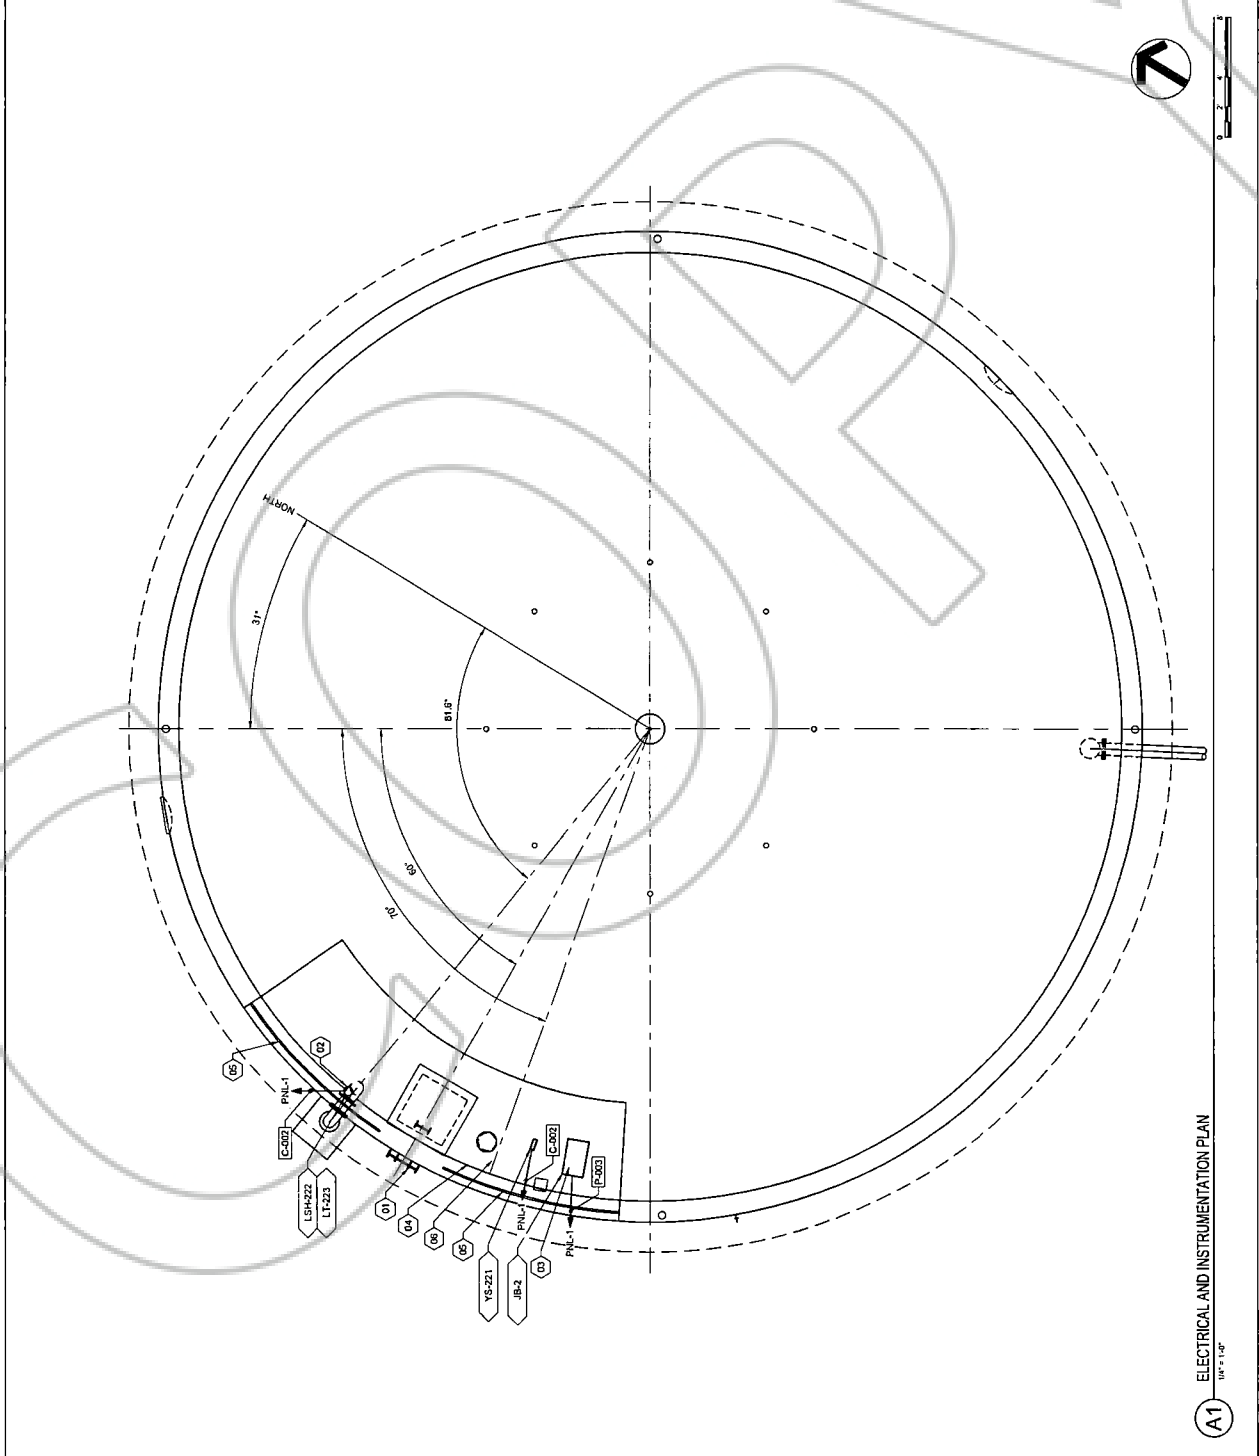


A1 ELECTRICAL AND INSTRUMENTATION PLAN
 1/16" = 1'-0"

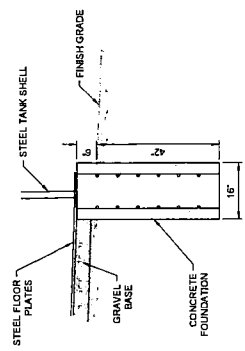


B1 TANK FOUNDATION
 N.T.S.

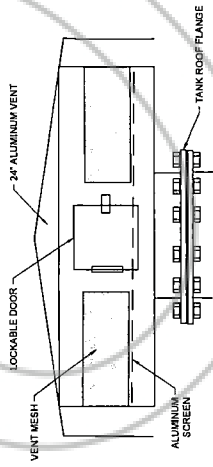


B2 TANK ROOF VENT
 N.T.S.

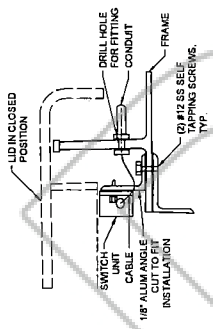


B4 HATCH PROXIMITY SWITCH
 N.T.S.

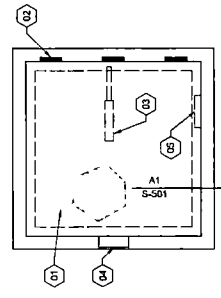

A1 ROOF HATCH COVER PLAN
 N.T.S.

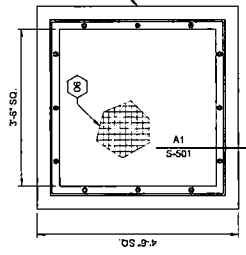


ROOF HATCH FRAME PLAN

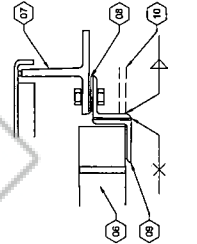

ROOF HATCH SECTION

- ROOF HATCH NOTES:**
- D1 ALUMINUM ROOF HATCH
 - D2 GAS SPRING DOOR ASSIST
 - D3 LOCKABLE LATCH
 - D4 DOOR PROXIMITY SWITCH
 - D5 ALUMINUM HATCH FRAME
 - D6 NEOPRENE GASKET
 - D7 TANK ROOF PLATE

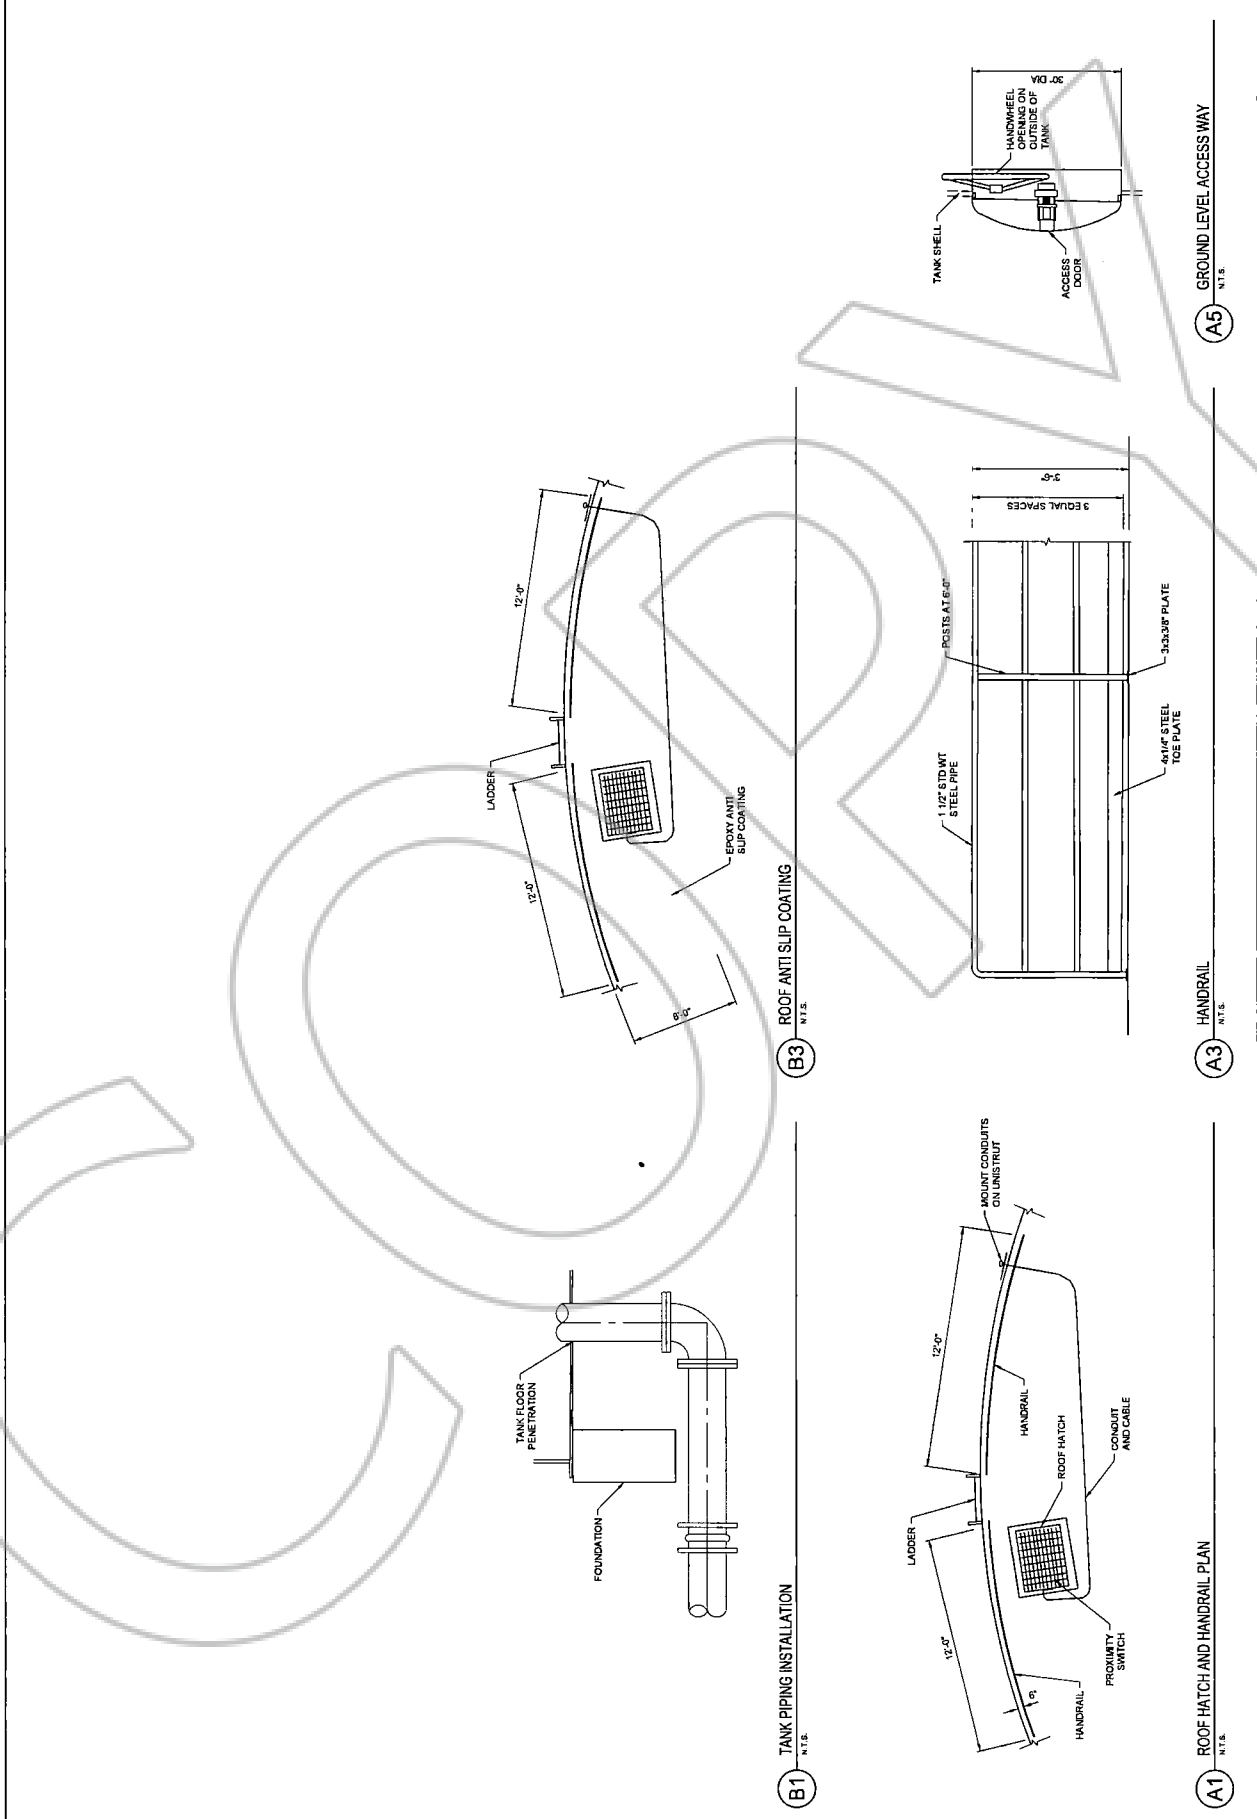

B3 ROOF ANTI SLIP COATING
 N.T.S.

B1 TANK PIPING INSTALLATION
 N.T.S.


A3 HANDRAIL
 N.T.S.

A1 ROOF HATCH AND HANDRAIL PLAN
 N.T.S.

A5 GROUND LEVEL ACCESS WAY
 N.T.S.

NO.	REVISIONS	DATE




- CATHODIC PROTECTION NOTES:
- 01 ANODES
 - 02 ANODE SUPPORTS
 - 03 ANODE CABLES
 - 04 COPPER SULFATE
 - 05 COPPER SULFATE REFERENCE CELL
 - 06 SYSTEM CABLING
 - 07 ANODE CONNECTION POINT FOR EXPOSED CABLING
 - 08 STAINLESS STEEL JUNCTION BOX
 - 09 CONNECTION FROM TANK SHELL METAL TO ANODE PROTECTION SYSTEM
 - 10 RELEASE COUPLER
 - 11 ONE ANODE NEAR HATCH
 - 12 ANODE CONTROL STATION
 - 13 TANK ROOF COLUMNS

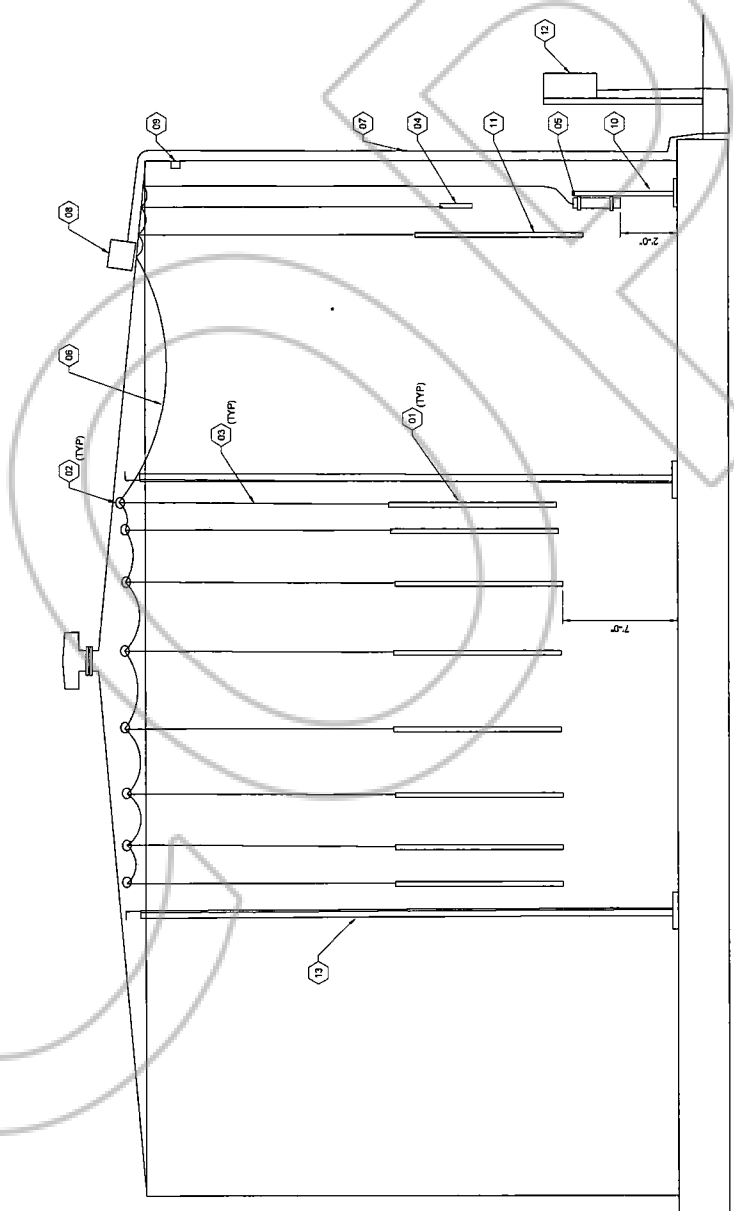

A1 CATHODIC PROTECTION ELEVATION
 N.T.S.

NO.	REVISIONS	DATE

This document is the property of Keller Associates. It and shall not be copied or any form without the written authorization of Keller Associates, Inc.

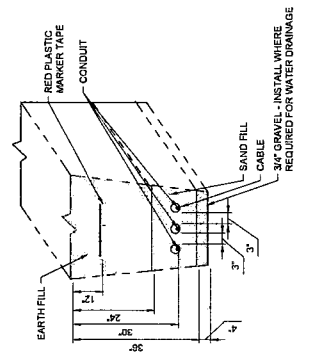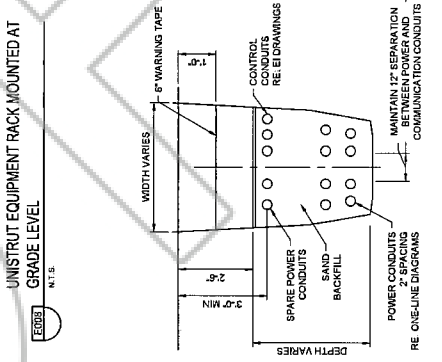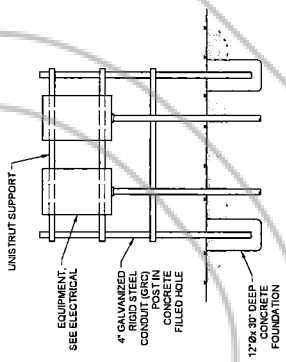

GENERAL SHEET NOTES

- CONTRACTOR TO PROVIDE ALL EQUIPMENT AND ACCESSORIES FOR THE PROJECT.
- COORDINATE WORK AND TRENCH LOCATIONS WITH RELATED TRADES.
- ROUTE CONDUIT IN COMMON TRENCH WHEREVER POSSIBLE.
- POSITIONS SHALL PROVIDE A CHECK CIRCUIT BREAKER.
- CONTRACTOR SHALL PROVIDE NEW UPDATED DIRECTORIES FOR ALL ELECTRICAL EQUIPMENT TO BE FIELD MARKED PER THE ALL ELECTRIC CODES SHALL BE MARKED AS SPARE.
- NEC 110.16 POTENTIAL ELECTRIC ARC FLASH HAZARD.

SHEET KEYNOTES


- EXISTING TANK FOR DEMO. COORDINATE WITH INTEGRATOR FOR RELOCATION OF ANTENNA.
- SEE CONSTRUCTION PHASING REQUIREMENTS FOR NEW TANK TO BE INSTALLED. EQUIPMENT TO BE IN PLACE PRIOR TO SWITCH OVER IN ORDER TO MINIMIZE TIME OFF-LINE.
- RETURN ELECTRICAL AND CONTROLS EQUIPMENT SHOWN FOR DEMO TO OWNER.
- INSTALL NEW ACRAMP AC CURRENT SWITCH MODEL ASST/DA/EA FOR EACH GRIDBEE MIXER CONDUCTOR. RETAIN/REMOVE EXISTING CURRENT TRANSFORMER FOR EACH GRIDBEE MIXER'S PANEL LIGHTS.
- INSTALL RELAY FOR EACH GRIDBEE MIXER. RETAIN/MATCH EXISTING RELAYS. PROVIDE A SECOND RELAY AS FIELD SPARE FOR EACH GRIDBEE MIXER.

EQUIPMENT KEYNOTES

- ANT-1 RELOCATED ANTENNA
- ICCP-1 TANK 1 IMPRESSED CURRENT CATHODIC PROTECTION SYSTEM
- ICCP-2 TANK 2 IMPRESSED CURRENT CATHODIC PROTECTION SYSTEM
- INV INVERTER WITH MINI MAGNUM PANEL
- JB-1 MANUFACTURER PROVIDED TOP OF TANK 1 JUNCTION BOX
- JB-2 MANUFACTURER PROVIDED TOP OF TANK 2 JUNCTION BOX
- MIXER-1 TANK 1 GRIDBEE MIXER
- MIXER-2 TANK 2 GRIDBEE MIXER
- MMP-1 MINI MAGNUM PANEL
- MPPT CHARGE CONTROLLER
- PNL-1 EXISTING PANEL
- SLR-1 SOLAR MODULES
- SCADA SCADA CONTROLS AND RADIO EQUIPMENT
- TANK-1 NEW TANK 1
- TANK-2 NEW TANK 2

LEGEND

- NEW EQUIPMENT
- FUTURE EQUIPMENT
- EXISTING EQUIPMENT
- UNDERGROUND CONDUIT

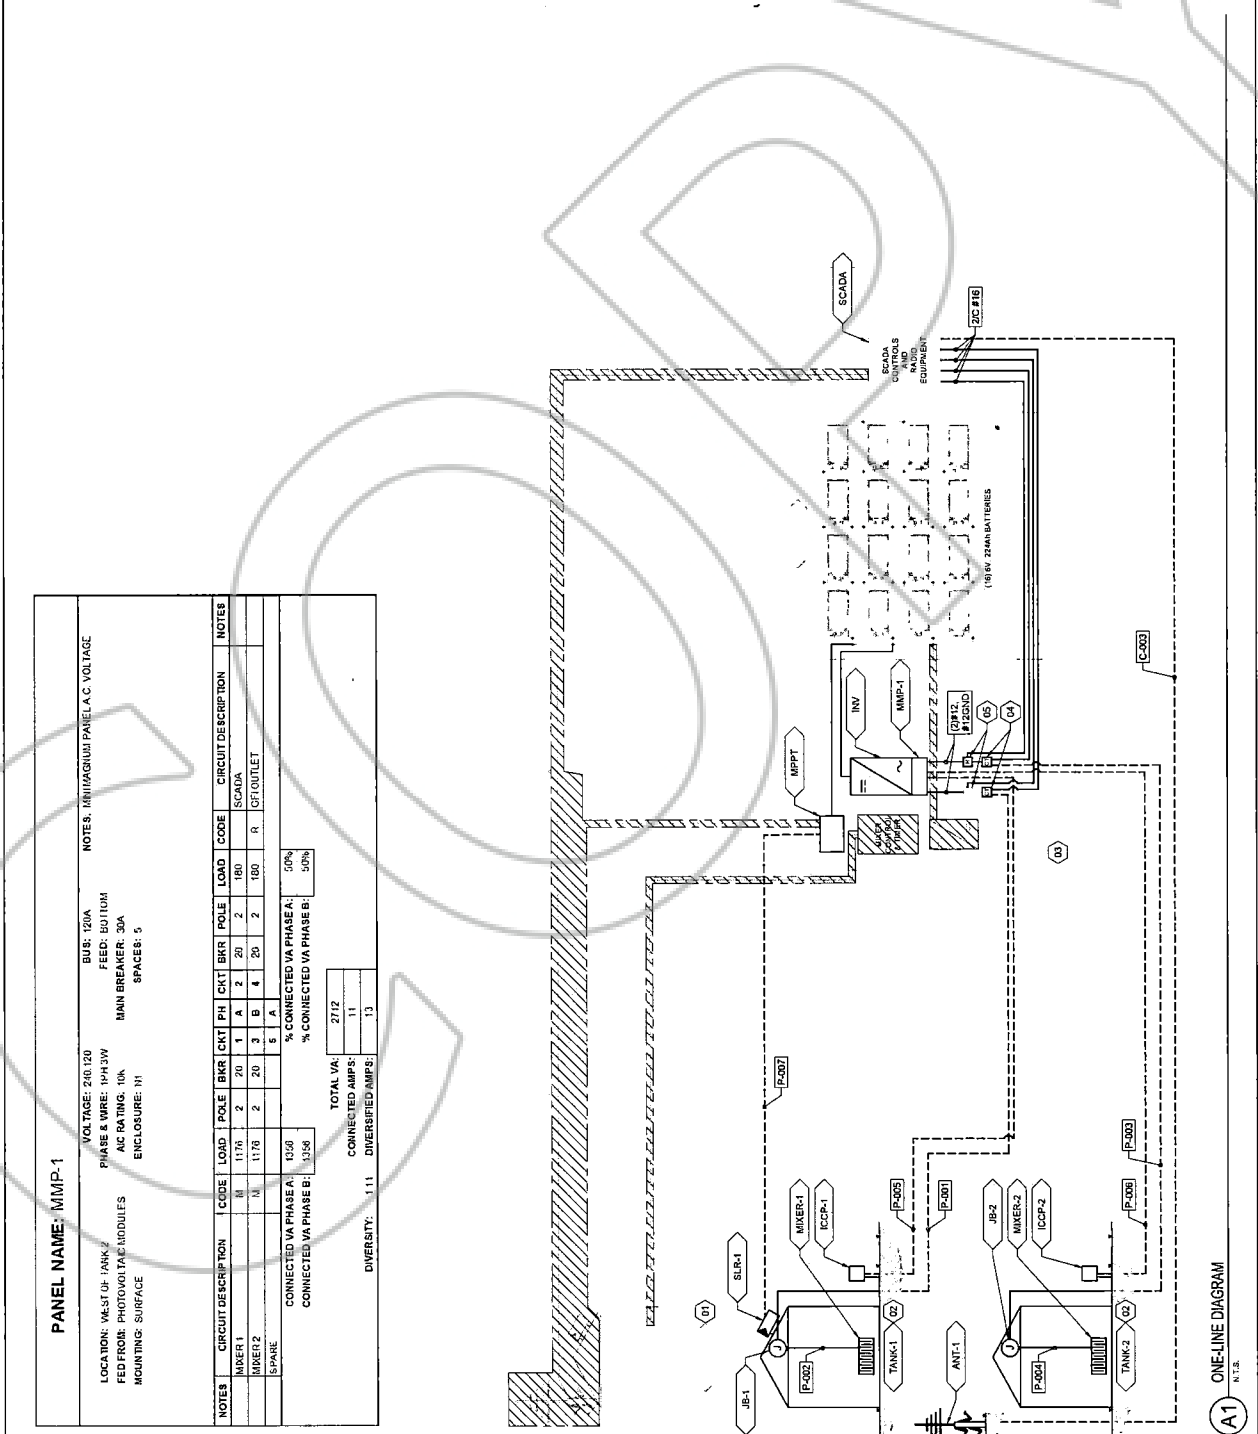

ELECTRICAL CABLE AND CONDUIT SCHEDULE


CONDUIT TAG	REF. SHEET	CONDUIT SPEC	CABLE SPEC	SERVICE	DESCRIPTION	ORIGIN	DESTINATION	NOTES
P-001	E 120, E 601	3/4"	(2) #12, #12 CHD	120V	TANK 1 GRODDEE WIKER	PNL 1	JB-1	
P-002	E 601	N/A	MANUFACTURER'S CABLE	120V	TANK 1 GRODDEE WIKER	JB-1	WIKER-1	
P-003	E 120, E 601	3/4"	(2) #12, #12 CHD	120V	TANK 2 GRODDEE WIKER	PNL 1	JB-2	
P-004	E 601	N/A	MANUFACTURER'S CABLE	120V	TANK 2 GRODDEE WIKER	JB-2	WIKER-2	
P-005	E 120, E 601	MATCH EXISTING	MATCH EXISTING	N/A	SOLAR MODULES	SUB 1	APPT	




*NOTE: CONDUIT SPECIFICATION IS INDICATIVE OF THE TYPE OF INSTALLATION REQUIRED FOR MAJORITY OF CABLE ROUTING. EC IS RESPONSIBLE FOR ALL WIRING METHODS AND MATERIALS INCLUDING CONDUIT TRANSITIONS, SUPPORTS, PENETRATIONS, ETC. AS REQUIRED FOR A COMPLETE INSTALLATION AND MEETING ALL REQUIREMENTS

CONTROL CABLE AND CONDUIT SCHEDULE

CONDUIT TAG	REF. SHEET	CONDUIT SPEC	CABLE SPEC	SERVICE	DESCRIPTION	ORIGIN	DESTINATION	NOTES
C-001	E 120, E 601	3/4"	210416	DISCRETE	TANK 1 MATCH INTERLOCK	PNL 1	TA-111	
C-002	E 120, E 601	3/4"	210416	DISCRETE	TANK 1 HIGH LEVEL	PNL 1	LSH-112	
C-003	E 120, E 601	3/4"	1PR #18 TWDS	ANALOG	TANK 1 LEVEL	PNL 1	LT-113	
C-004	E 120, E 601	3/4"	210416	DISCRETE	TANK 2 MATCH INTERLOCK	PNL 1	TA-221	
C-005	E 120, E 601	3/4"	210416	DISCRETE	TANK 2 HIGH LEVEL	PNL 1	LSH-222	
C-006	E 120, E 601	3/4"	1PR #18 TWDS	ANALOG	TANK 2 LEVEL	PNL 1	LT-223	
C-007	E 120, E 601	MATCH EXISTING	MATCH EXISTING	N/A	ANTENNA	APPT 1	SCADA	





*NOTE: CONDUIT SPECIFICATION IS INDICATIVE OF THE TYPE OF INSTALLATION REQUIRED FOR THE MAJORITY OF THE CABLE ROUTING. EC IS RESPONSIBLE FOR ALL WIRING METHODS AND MATERIALS INCLUDING CONDUIT TRANSITIONS, SUPPORTS, PENETRATIONS, ETC. AS REQUIRED FOR A COMPLETE INSTALLATION AND MEETING ALL REQUIREMENTS OF ARTICLE 300 OF THE NATIONAL ELECTRIC CODE.
 ALL SIGNAL AND NETWORK CABLES ARE TO BE SPACED FROM POWER CONDUCTORS.
 CABLE VOLTAGE & SIZE SHALL BE ROUTED IN A SEPARATE FACEDWAY OR SUBSEGMENTED VIA PHYSICAL BARRIERS SEPARATION AND/OR MINIMUM DISTANCE OF 12 IN. FROM SIGNAL CABLES, MAINTAINED FOR ENTIRE LENGTH OF CABLE RUN.

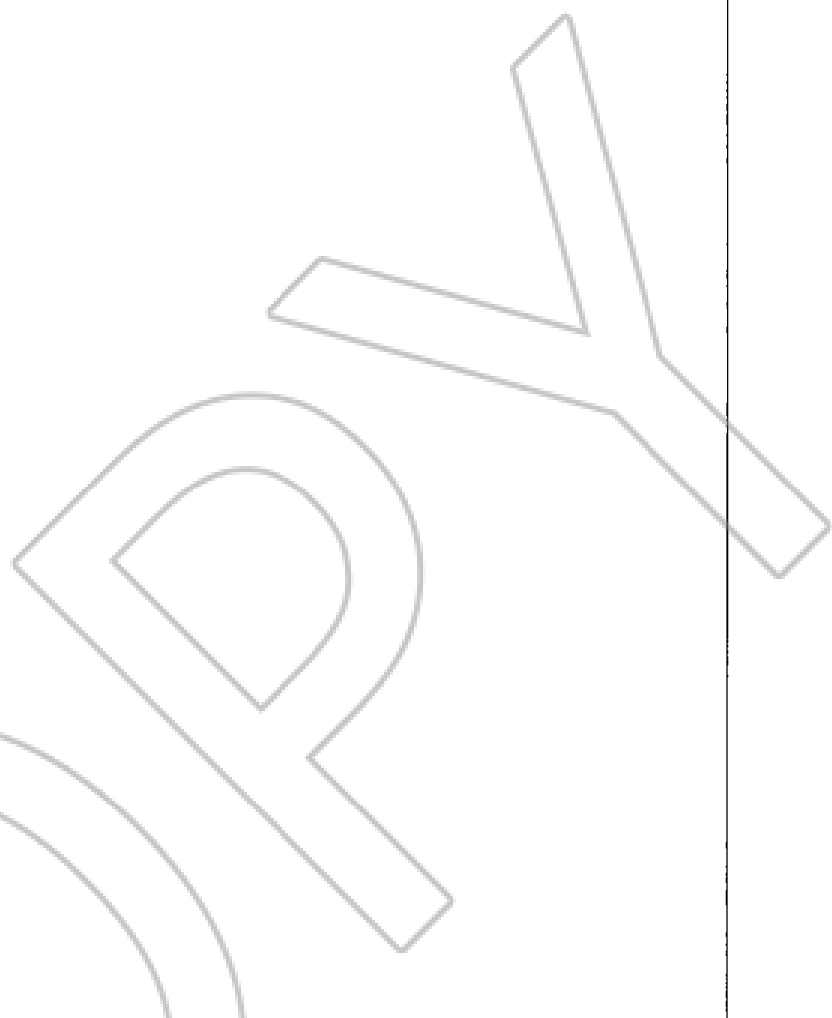

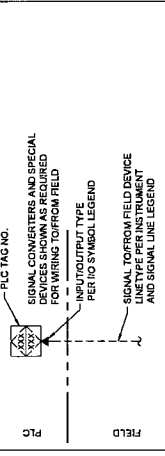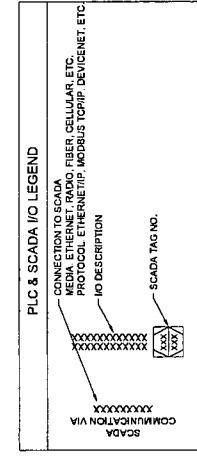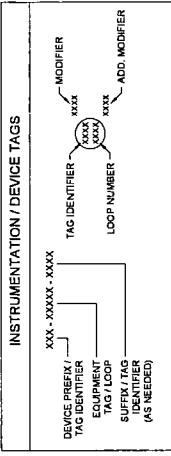

INSTRUMENT TAG IDENTIFICATION LETTERS

MEASURED VARIABLE	INSTRUMENT FUNCTION	ELEMENT	TRANSMITTER	CONVERTER / TRANSDUCER	INDICATOR	RECORDER	CONTROLLER	SWITCH LOW LOW	SWITCH HIGH	SWITCH HIGH HIGH	ALARM LOW	ALARM HIGH	ALARM HIGH HIGH	TOTALIZE	VALVE	GAUGE	LIGHT
A	ANALOG	AI	AI	AI	AI	AI	AI	AI	AI	AI	AI	AI	AI	AI	AI	AI	AI
B	ANALOG	BI	BI	BI	BI	BI	BI	BI	BI	BI	BI	BI	BI	BI	BI	BI	BI
C	CONDUCTIVITY	CE	CE	CE	CE	CE	CE	CE	CE	CE	CE	CE	CE	CE	CE	CE	CE
D	DENSITY	DE	DE	DE	DE	DE	DE	DE	DE	DE	DE	DE	DE	DE	DE	DE	DE
E	ELONGATION	EE	EE	EE	EE	EE	EE	EE	EE	EE	EE	EE	EE	EE	EE	EE	EE
F	FLOW	FI	FI	FI	FI	FI	FI	FI	FI	FI	FI	FI	FI	FI	FI	FI	FI
G	GAUGE	GI	GI	GI	GI	GI	GI	GI	GI	GI	GI	GI	GI	GI	GI	GI	GI
H	HAND	HI	HI	HI	HI	HI	HI	HI	HI	HI	HI	HI	HI	HI	HI	HI	HI
I	INDICATOR	II	II	II	II	II	II	II	II	II	II	II	II	II	II	II	II
J	JUNCTION	JI	JI	JI	JI	JI	JI	JI	JI	JI	JI	JI	JI	JI	JI	JI	JI
K	LEVEL	KI	KI	KI	KI	KI	KI	KI	KI	KI	KI	KI	KI	KI	KI	KI	KI
L	LEVEL	LI	LI	LI	LI	LI	LI	LI	LI	LI	LI	LI	LI	LI	LI	LI	LI
M	MOISTURE	MI	MI	MI	MI	MI	MI	MI	MI	MI	MI	MI	MI	MI	MI	MI	MI
N	MOISTURE	NI	NI	NI	NI	NI	NI	NI	NI	NI	NI	NI	NI	NI	NI	NI	NI
O	ORBITAL	OI	OI	OI	OI	OI	OI	OI	OI	OI	OI	OI	OI	OI	OI	OI	OI
P	PRESSURE OR VACUUM	PI	PI	PI	PI	PI	PI	PI	PI	PI	PI	PI	PI	PI	PI	PI	PI
Q	QUANTITY	QI	QI	QI	QI	QI	QI	QI	QI	QI	QI	QI	QI	QI	QI	QI	QI
R	RADIO	RI	RI	RI	RI	RI	RI	RI	RI	RI	RI	RI	RI	RI	RI	RI	RI
S	SPEED	SI	SI	SI	SI	SI	SI	SI	SI	SI	SI	SI	SI	SI	SI	SI	SI
T	TEMPERATURE	TI	TI	TI	TI	TI	TI	TI	TI	TI	TI	TI	TI	TI	TI	TI	TI
U	MULTIVARIABLE	UI	UI	UI	UI	UI	UI	UI	UI	UI	UI	UI	UI	UI	UI	UI	UI
V	VIBRATION	VI	VI	VI	VI	VI	VI	VI	VI	VI	VI	VI	VI	VI	VI	VI	VI
W	WEIGHT	WI	WI	WI	WI	WI	WI	WI	WI	WI	WI	WI	WI	WI	WI	WI	WI
X	UNCLASSIFIED	XI	XI	XI	XI	XI	XI	XI	XI	XI	XI	XI	XI	XI	XI	XI	XI
Y	EVENT / STATUS	YI	YI	YI	YI	YI	YI	YI	YI	YI	YI	YI	YI	YI	YI	YI	YI
Z	POSITION	ZI	ZI	ZI	ZI	ZI	ZI	ZI	ZI	ZI	ZI	ZI	ZI	ZI	ZI	ZI	ZI

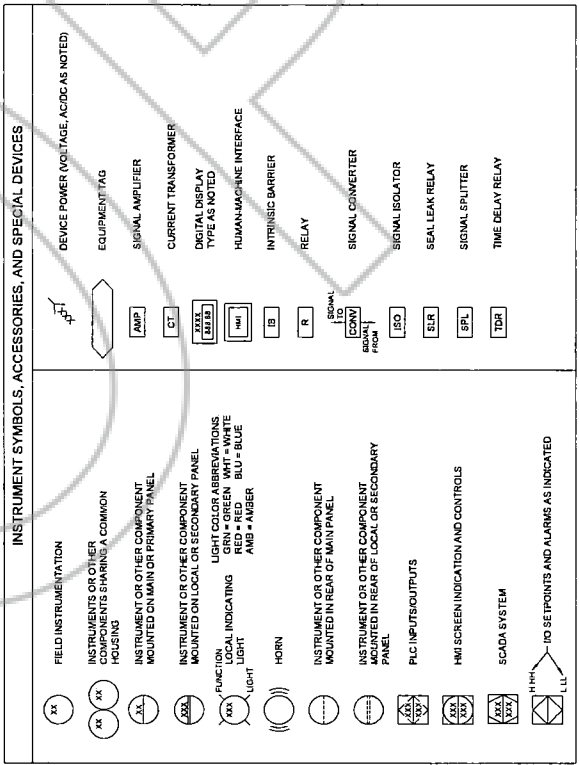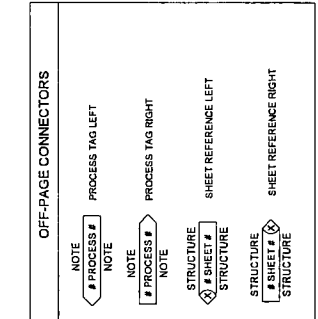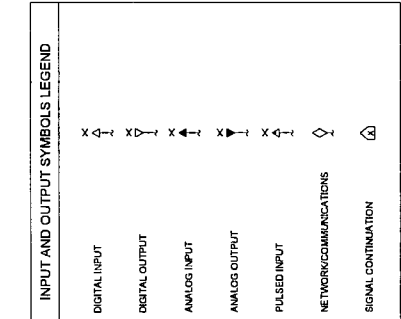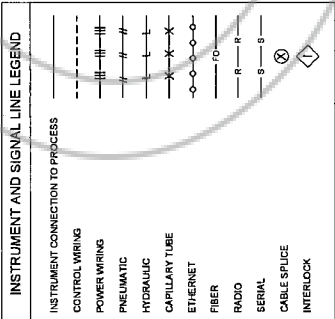

GENERAL ABBREVIATIONS

AFF	ABOVE FINISH FLOOR	AG	ABOVE GROUND	ATM	ATMOSPHERE	BYP	BYPASS	EL	ELEVATION	ETM	ELAPSED TIME / METER	FC	FAIL CLOSE	FO	FAIL OPEN	FOR	FORWARD / OFF / REVERSE	FL	FAIL LAST	HMI	HUMAN-MACHINE INTERFACE	HQA	HAND/OFF/AUTOMATIC	HPT	HIGH POINT	HS	HAND SWITCH	JKT	JACKET	XO	TIMEOFF	LC	LOCKED CLOSE	LCP	LOCAL CONTROL PANEL	LCS	LOCAL CONTROL STATION	LO	LOCKED OPEN	LOR	LOCAL OFF REMOTE	LPT	LOW POINT	LR	LOCAL REMOTE	MAX	MAXIMUM	MCC	MOTOR CONTROL CENTER
MCP	MOTOR CONTROL PANEL	MIN	MINIMUM	NC	NORMALLY CLOSED	NO	NORMALLY OPEN	NNF	NORMALLY NO FLOW	OC	OPEN/CLOSE	OH	OVERHEAD	OO	OUT OF SERVICE	PLC	PROGRAMMABLE LOGIC CONTROLLER	POT	POTENTIOMETER	RCP	REMOTE CONTROL PANEL	REQD	REQUIRED	REL	RAISE/STOP/LOWER	RTU	REMOTE TELEMETRY UNIT	SCADA	SUPERVISORY CONTROL AND DATA ACQUISITION	SEL	SELECT	SP	SET POINT	SMP	SAMPLE POINT	TL	TANGENT LINE	TSD	TIGHT SHUTOFF	UG	UNDER GROUND	VAC	VACUUM	VCP	VEHICULAR CONTROL PANEL	VT	VENT		

PIPE FITTINGS	EQUIPMENT
FLANGE	BIN
FLANGE REDUCING	HEATER
ORIFICE UNION	BARREL
ECCENTRIC UNION (FLAT SIDE DOWN)	OPEN BULK STORAGE
ECCENTRIC UNION (FLAT SIDE UP)	CONVEYOR
CAP (THREADED)	ROTIARY FEEDER
CAP (WELDED)	AUTOMATIC TRANSFER SWITCH
HOSE CONNECTION	GENERATOR
PLUG	MANUAL BAR SCREEN
CAP	PLATE AND FRAME HEAT EXCHANGER
HOSE CONNECTION (FEMALE)	SHELL AND TUBE HEAT EXCHANGER
HOSE CONNECTION (MALE)	AERATOR
REDUCER	FAN
FLEXIBLE HOSE	ELECTRIC MOTOR
BLIND FLANGE	AGITATORY MIXER
	SCREW CONVEYOR
	SOFT STARTER
	STARTER
	VARIABLE FREQUENCY DRIVE

PIPE FITTINGS	EQUIPMENT
FLANGE	TANK OPEN
FLANGE REDUCING	TANK CLOSED
ORIFICE UNION	TANK COVERED
ECCENTRIC UNION (FLAT SIDE DOWN)	TANK DOME ROOF
ECCENTRIC UNION (FLAT SIDE UP)	TANK CONE ROOF
CAP (THREADED)	TANK DOUBLE WALL
CAP (WELDED)	TOTE
HOSE CONNECTION	DRUM
PLUG	VESSEL
CAP	
HOSE CONNECTION (FEMALE)	
HOSE CONNECTION (MALE)	
REDUCER	
FLEXIBLE HOSE	
BLIND FLANGE	

PIPING COMPONENTS	EQUIPMENT
SAMPLE POINT	TANK OPEN
BREATHER	TANK CLOSED
DAMPER	TANK COVERED
VENT COVER	TANK DOME ROOF
SILENCER	TANK CONE ROOF
AIR FILTER	TANK DOUBLE WALL
EXPANSION JOINT	TOTE
FLEXIBLE HOSE CONNECTION	DRUM
FLOW CONDITIONER	VESSEL
EXPANSION CHAMBER	
FLOOR DRAIN	
GRINDER	
HOSE RACK	
STATIC MIXER	
IN-LINE MIXER	
PULSATION DAMPENER	
ROOF DRAIN	
RUPTURE DRK	
SIGHT GLASS	
SURGE DAMPENER	
TRENCH DRAIN	
WAFER-TYPE STATIC MIXER	

PROCESS SERVICE CODES	PIPING COMPONENTS
AL AIR LOW PRESSURE	Y STRAINER
ALP BACKWASH	ACCUMULATOR
BW COMPRESSED AIR	BASKET STRAINER
CA CHEMICAL	AREA DRAIN
CHM CLEAN IN PLACE	CONDENSATE TRAP
CIP CHLORINE SOLUTION	DEMBTER
CLS CIRCULATED SLUDGE	EJECTOR / REDUCTOR
DR DRAIN	COLLECTION TO DRAIN
DG DIGESTER GAS	
DS DIGESTED SLUDGE	
FA FOULAIR	
FC FERRIC CHLORIDE	
FLT FILTRATE	
HSL HEATED SLUDGE LINE	
HWR HEATING WATER RETURN	
HWS HEATING WATER SUPPLY	
ML MIXED LIQUOR	
NG NATURAL GAS	
OF OVERFLOW	
PD PUMFED DRAIN/PLANT DRAIN	
PE PRIMARY EFFLUENT	
PLR POLYMER	
PS PRESSURE SEWER	
RAS RETURN ACTIVATED SLUDGE	
RS RAW SEWAGE	
SA SAMPLE	
SCM SCUM	
SD STORM DRAIN	
SE SECONDARY EFFLUENT	
SID SLUDGE	
SS SLUMP PUMP DISCHARGE	
TS SANITARY SEWER (GRAVITY)	
TE TERTIARY EFFLUENT	
V VENT	
WAS WASTE ACTIVATED SLUDGE	

PROCESS AND PIPING LINE LEGEND
MAIN PROCESS
SECONDARY PROCESS
CONNECTING LINES
NON-CONNECTING LINES
PIPE SPECIFICATION BREAK (AT LOWER PRESSURE SIDE WELD)
DIRECTION FLOW
SLOPING LINES
ELECTRICAL TRACING
JACKETED
FLANGES

PROJECT SCOPE LEGEND
EXISTING ITEM
NEW ITEM
FUTURE ITEM
DEMOLITION ITEM
RELOCATED/TO BE RELOCATED ITEM
VENDOR PROVIDED EQUIPMENT

LINE SIZE AND MATERIAL IDENTIFICATION
186201
SYSTEM NUMBER
PIPE TEST ID
12" PE (22A)
FLUID ABBREVIATION
PIPE DIAMETER

NOTE: REFER TO G-XXX PIPE SCHEDULE FOR SYSTEM NUMBER, PIPE TEST ID AND FLUID ABBREVIATIONS

BOUNDARIES
ABOVE GROUND
UNDERGROUND
LINE MATERIAL CLASS
SPEC 1
SPEC 2
INTERFACE BETWEEN CONTRACTOR/VENDOR
INSULATION BREAK
VENDOR EQUIPMENT
LIMITS PACKAGED
BATTERY LIMITS (BUILDING ENTRY/EXIT)
WATER SURFACE

VALVES

	ANGLE VALVE
	THREE-WAY VALVE
	FOUR-WAY VALVE
	AIR RELEASE VALVE

VALVE ACTUATORS

	PNEUMATIC DIAPHRAGM ACTUATOR, SINGLE OR DOUBLE ACTING
	VALVE POSITIONER
	HYDRAULIC OR PNEUMATIC CYLINDER ACTUATOR
	HANDWHEEL USED WITH ANY ACTUATOR
	MANUAL ACTUATOR
	MOTOR ACTUATOR
	SOLENOID ACTUATOR
	VALVE FAILURE STATE SHOWN FO = FAIL OPEN FC = FAIL CLOSED FL = FAIL LAST

SAFETY EQUIPMENT

	HOSE REEL
	EYE WASH
	SAFETY SHOWER
	SPRINKLER

VALVES

	BALL VALVE
	GATE VALVE
	GLOBE VALVE
	NEEDLE VALVE
	PINCH VALVE
	PLUG VALVE
	PRESSURE REGULATING VALVE
	BACK-PRESSURE REGULATING VALVE
	PRESSURE SAFETY VALVE
	SLIDE GATE
	STOP OR SHEAR GATE
	PRESSURE SAFETY VALVE WITH VENT
	VACUUM SAFETY VALVE
	VEE BALL VALVE
	BALANCED WEIGHT VALVE
	BALL CHECK VALVE
	BALL CHECK VALVE, SPRING LOADED
	BUTTERFLY VALVE
	CHECK VALVE
	ALTITUDE / BACK PRESSURE CONTROL VALVE LIMIT SWITCHES AND SOLENOIDS TO BE ADDED AS REQUIRED
	DIAPHRAGM VALVE
	DUCKBILL CHECK VALVE

PUMPS

	CENTRIFUGAL PUMP, FAN, OR BLOWER
	VERTICAL MULTISTAGE CENTRIFUGAL PUMP
	BLOWER OR COMPRESSOR
	TURBINE PUMP
	DIAPHRAGM PUMP
	POSITIVE DISPLACEMENT PUMP
	EJECTOR PUMP
	GEAR PUMP
	CHEMICAL METERING PUMP
	PISTON COMPRESSOR
	RECIPROCATING PUMP
	ROTARY VANE PUMP
	PROGRESSIVE CAVITY PUMP
	SUBMERSIBLE SLUMP PUMP
	ROTARY LOBE PUMP
	PERISTALTIC PUMP
	VACUUM PUMP
	VERTICAL TURBINE LINESHAFT PUMP

FLOW METERS

	ULTRASONIC FLOW METER
	CLAMP ON FLOW METER
	VORTEX FLOW METER
LEVEL	
	FLOAT SWITCH
	FLOAT SWITCH, TILT-TYPE
	TUNING FORK
	CAPACITANCE
	GUIDED WAVE RADAR
	RADAR, NON-CONTACT
	ULTRASONIC
	LASER
	INDUCTIVE RELAY LEVEL SWITCH
	VENT
	SUBMERSIBLE LEVEL
	ANALYZER PROBE

ACCESSORIES AND MISCELLANEOUS

	ANNULAR SEAL
	REMOTE ELECTRONIC PRESSURE SENSOR
	CALIBRATION COLUMN
	DIAPHRAGM SEAL, FLANGED
	DIAPHRAGM SEAL, THREADED OR SANITARY
	HORN
	PITOTAIL
	ROOM THERMOSTAT
	SNUBBER
	THEROWELL
	AIR REGULATOR/FILTER

FLOW METERS

	VENTURI FLOW METER
	MAGNETIC FLOW METER
	INSERTION MAGNETIC FLOW METER
	CORIOLIS FLOW METER
	PLATE FLOW METER, ORIFICE
	PARSHALL FLUME FLOW METER
	WEIR FLOW METER
	PITOT TUBE FLOW METER
	AVERAGING PITOT FLOW METER
	TURBINE FLOW METER
	ROTAMETER
	THERMAL DISPERSION FLOW METER

ACCESSORIES AND MISCELLANEOUS

	ANNULAR SEAL
	REMOTE ELECTRONIC PRESSURE SENSOR
	CALIBRATION COLUMN
	DIAPHRAGM SEAL, FLANGED
	DIAPHRAGM SEAL, THREADED OR SANITARY
	HORN
	PITOTAIL
	ROOM THERMOSTAT
	SNUBBER
	THEROWELL
	AIR REGULATOR/FILTER

ACCESSORIES AND MISCELLANEOUS

	ANNULAR SEAL
	REMOTE ELECTRONIC PRESSURE SENSOR
	CALIBRATION COLUMN
	DIAPHRAGM SEAL, FLANGED
	DIAPHRAGM SEAL, THREADED OR SANITARY
	HORN
	PITOTAIL
	ROOM THERMOSTAT
	SNUBBER
	THEROWELL
	AIR REGULATOR/FILTER

FLOW METERS

	VENTURI FLOW METER
	MAGNETIC FLOW METER
	INSERTION MAGNETIC FLOW METER
	CORIOLIS FLOW METER
	PLATE FLOW METER, ORIFICE
	PARSHALL FLUME FLOW METER
	WEIR FLOW METER
	PITOT TUBE FLOW METER
	AVERAGING PITOT FLOW METER
	TURBINE FLOW METER
	ROTAMETER
	THERMAL DISPERSION FLOW METER

ACCESSORIES AND MISCELLANEOUS

	ANNULAR SEAL
	REMOTE ELECTRONIC PRESSURE SENSOR
	CALIBRATION COLUMN
	DIAPHRAGM SEAL, FLANGED
	DIAPHRAGM SEAL, THREADED OR SANITARY
	HORN
	PITOTAIL
	ROOM THERMOSTAT
	SNUBBER
	THEROWELL
	AIR REGULATOR/FILTER

ACCESSORIES AND MISCELLANEOUS


	ANNULAR SEAL
	REMOTE ELECTRONIC PRESSURE SENSOR
	CALIBRATION COLUMN
	DIAPHRAGM SEAL, FLANGED
	DIAPHRAGM SEAL, THREADED OR SANITARY
	HORN
	PITOTAIL
	ROOM THERMOSTAT
	SNUBBER
	THEROWELL
	AIR REGULATOR/FILTER

FLOW METERS

	VENTURI FLOW METER
	MAGNETIC FLOW METER
	INSERTION MAGNETIC FLOW METER
	CORIOLIS FLOW METER
	PLATE FLOW METER, ORIFICE
	PARSHALL FLUME FLOW METER
	WEIR FLOW METER
	PITOT TUBE FLOW METER
	AVERAGING PITOT FLOW METER
	TURBINE FLOW METER
	ROTAMETER
	THERMAL DISPERSION FLOW METER

ACCESSORIES AND MISCELLANEOUS


	ANNULAR SEAL
	REMOTE ELECTRONIC PRESSURE SENSOR
	CALIBRATION COLUMN
	DIAPHRAGM SEAL, FLANGED
	DIAPHRAGM SEAL, THREADED OR SANITARY
	HORN
	PITOTAIL
	ROOM THERMOSTAT
	SNUBBER
	THEROWELL
	AIR REGULATOR/FILTER

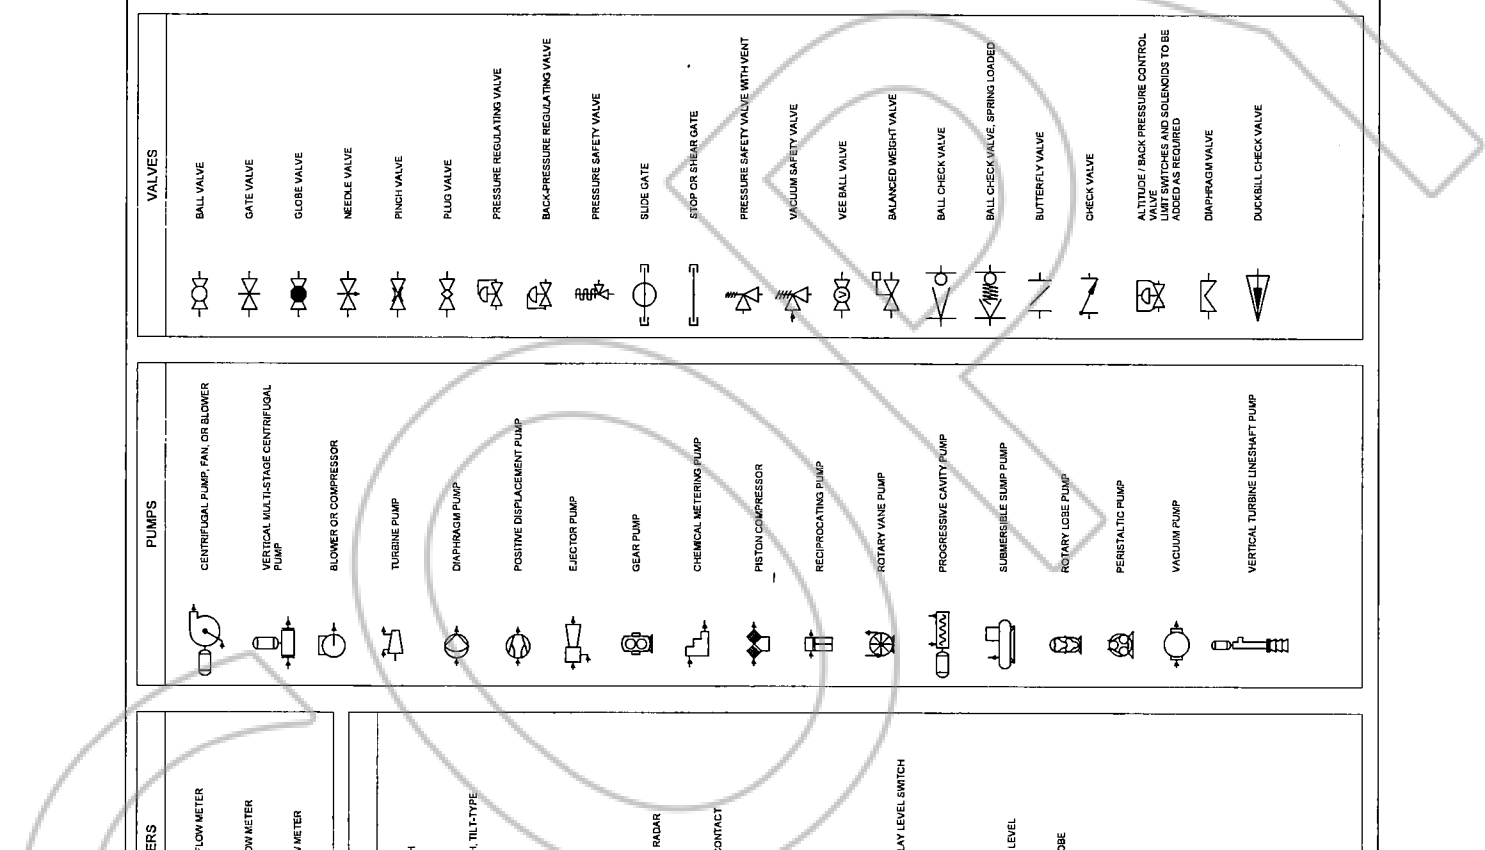



Design
Review
Not For
Construction

NO REVISIONS
The document is not to be used for design purposes as the prepared project of Keller Associates with a signature of Keller Associates, Inc.
DATE

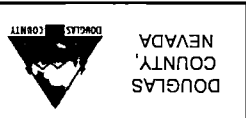

PAID
MOUNTAIN VIEW WATER TANK
REPLACEMENT

DRAWN: JH DECK DC
VERIFY SCALE. Scales based on 22"x34" prints.
PROJECT NO: 223125
PAGE: 1-12 (12/24)
SHEET NO: EI-701

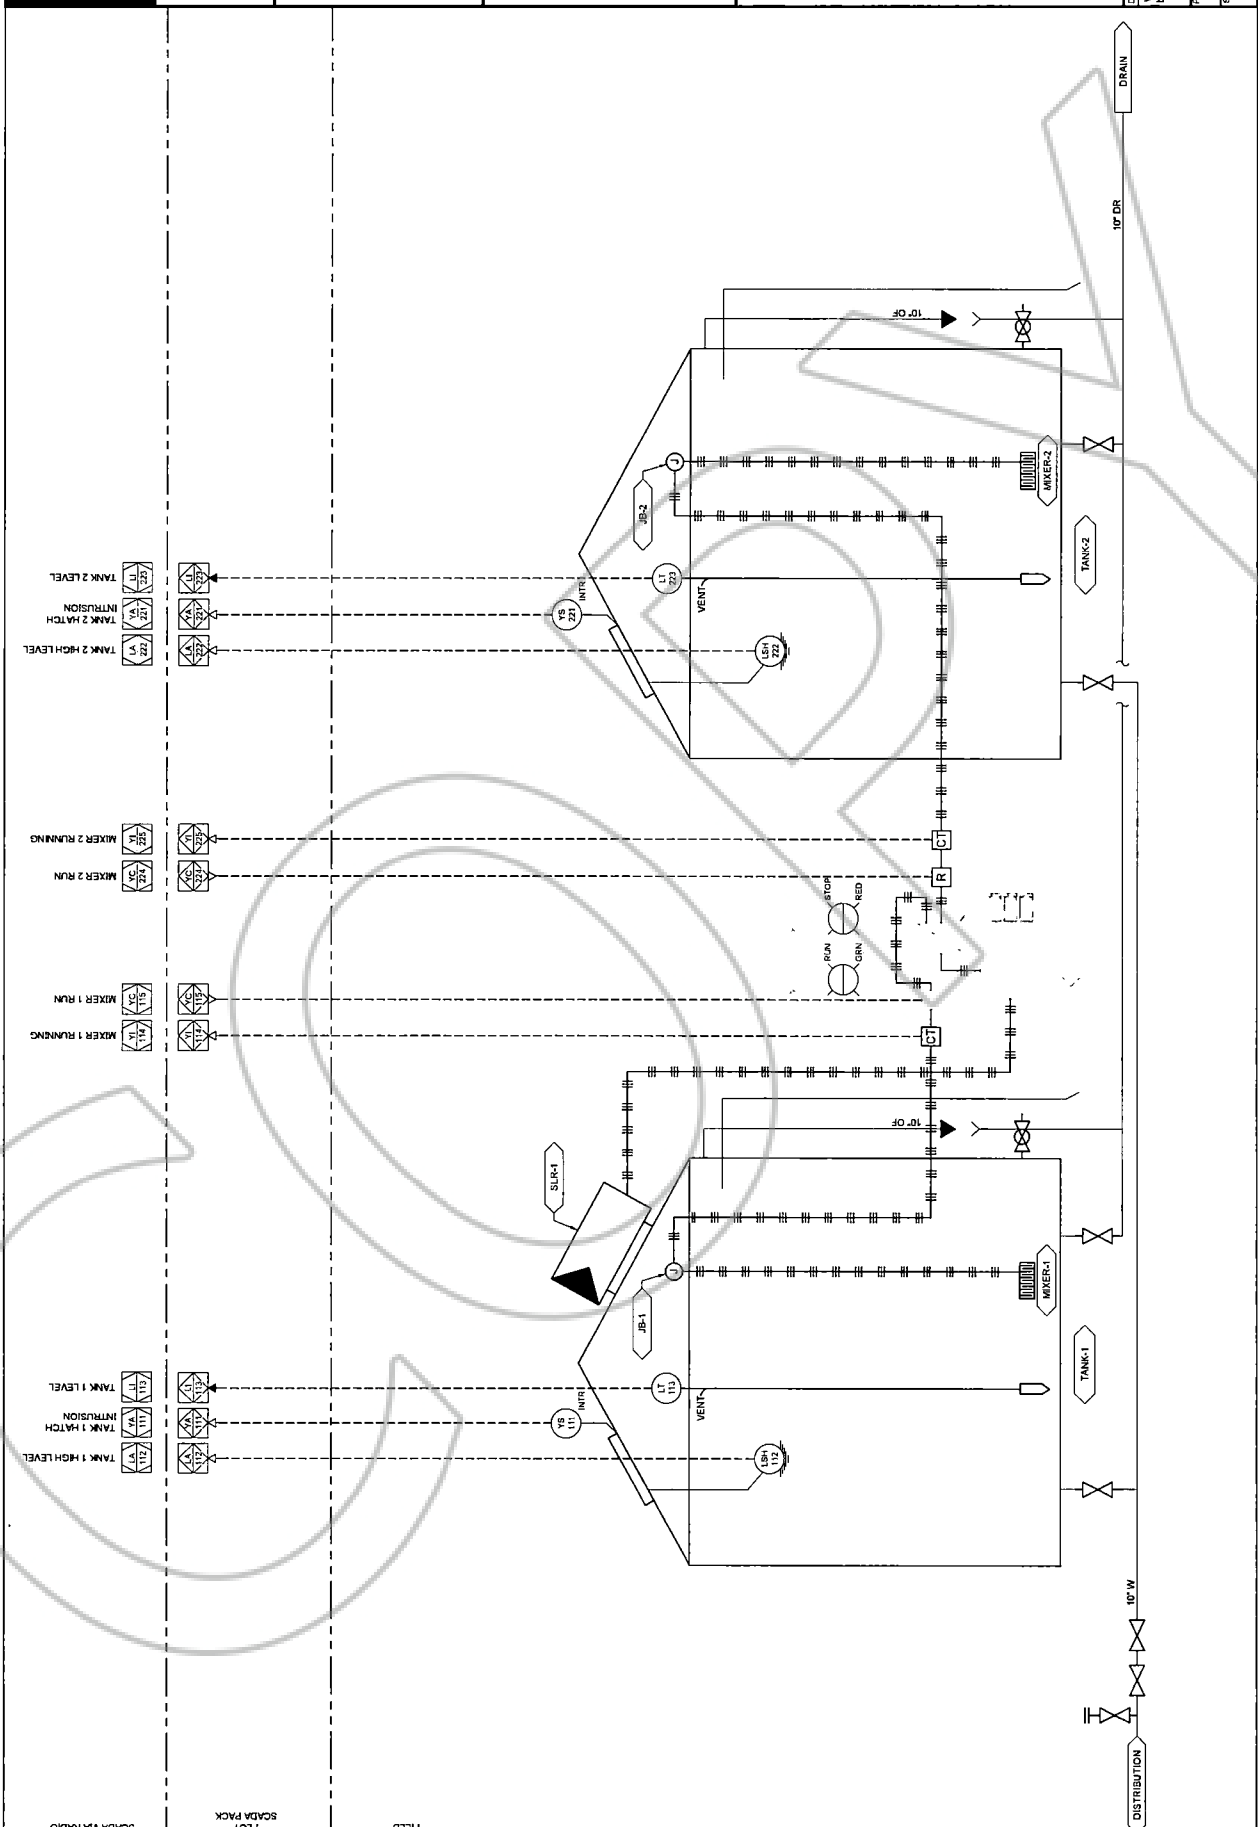


Exhibit C - Additional Terms and Conditions

Abbreviations

BLM U.S. Department of the Interior, Bureau of Land Management, Sierra Front Field Office
POD Plan of Development

Definitions

Grant: the instrument that the BLM has issued to the holder authorizing the use of public lands.

Holder: the entity to whom the BLM has issued grant no. N-045053.

Authorized officer: the individual to whom has been delegated the authority to approve all actions required for the granting and management of rights-of-way REFER TO BLM MANUAL 1203 within the Sierra Front Field Office. During the term of the grant, the holder shall contact the authorized officer through their designated representative:

Sierra Front Field Office
Attn: Assistant Field Manager
Lands and Realty
5665 Morgan Mill Road
Carson City, Nevada 89701
Telephone: (775) 885-6000

Right-of-way: the public lands that the BLM has authorized the holder to use or occupy under N-045053. The holder may only use the right-of-way for the specific use the grant authorizes, as determined by the authorized officer.

Facility: an improvement or structure, whether existing or planned, that is or would be owned and controlled by the holder within a right-of-way.

Notice to proceed: a written authorization, issued on Form 2800-15 Right-of-way Notice to Proceed, by the authorized officer that allows the holder to initiate actions under the grant. The authorized officer may issue separate notices to proceed if the grant involves distinct work phases and/or locations. Each notice to proceed will specify the nature of work, location, and dates to be authorized.

Substantial deviation: a change in the authorized location or use which requires:

- 1) Construction or use outside the boundaries of the right-of-way; or
- 2) Any change from, or modification of, the authorized use. Examples of substantial deviation may include: adding equipment, overhead or underground lines, pipelines, structures, or other facilities not included in the grant.

Surface disturbing activities: any authorized action that disturbs vegetation and/or surface soil.

General	
a.	This grant is subject to all valid rights existing on the effective date of the grant.
b.	This grant is issued subject to the holder also obtaining permits or clearances from applicable Federal agencies, State, Tribal, County, and other local authorities with regulatory authority over the approved land uses described herein.
c.	The holder shall contact the authorized officer, either in writing or by telephone, and obtain written approval prior to beginning any activity that is a substantial deviation from this grant or that will cause new surface disturbance.
d.	In case of change of address, the holder shall immediately notify the authorized officer in writing as previously described.
e.	The holder of this grant or the holder's successor in interest shall comply with Title VI of the Civil Rights Act of 1964 (42 U.S.C. 2000d et seq.) and the regulations of the Secretary of the Interior issued pursuant thereto.
f.	The holder shall conduct all activities associated with the construction, operation, and termination of the facility within the authorized limits of the right-of-way.
g.	The holder shall maintain the right-of-way in a safe, usable condition, as directed by the authorized officer.
h.	All design, material, and construction, operation, maintenance, and termination practices shall be in accordance with safe and proven engineering practices.
i.	The right-of-way shall be maintained in a sanitary condition at all times; waste material at those sites shall be properly contained and disposed of promptly at an appropriate waste disposal site. "Waste" means all discarded matter including, but not limited to, human waste, trash, garbage, refuse, oil drums, used petroleum products, ashes, and equipment.
j.	No signs or advertising devices shall be placed on the right-of-way or on adjacent public lands, nor on approved facilities, except those posted by or approved in writing by the authorized officer.
Holder's Representative	
k.	The holder shall designate a representative(s) who shall have the authority to act upon and to implement instructions from the authorized officer. The holder's representative shall be available for communication with the authorized officer within a reasonable time when construction or other surface disturbing activities are underway.
Public Access and Use of Lands	
l.	The holder shall permit free and unrestricted public access to and upon the right-of-way for all lawful purposes except for those specific areas designated as restricted by the authorized officer to protect the public, wildlife, livestock, or facilities constructed within the right-of-way.
m.	The holder shall provide for the safety of the public entering the right-of-way. This includes, but is not limited to, barricades for open trenches, flagmen/women with communication systems for single-lane roads without inter-visible turnouts, and signage of hazards.
n.	Existing roads and trails on public lands that are blocked as the result of the holder's construction, operations, or maintenance activities shall be rerouted or rebuilt as directed by the authorized officer.

Road Maintenance	
o.	The road proposed as part of this grant shall be constructed and maintained in accordance with the BLM standards prescribed for a resource type road.
p.	The holder shall furnish and install culverts of the gauge, materials, diameter(s), and length(s) indicated and approved by the authorized officer. Culverts shall be free of corrosion, dents, or other deleterious conditions. Culverts shall be placed on channel bottoms on firm, uniform beds which have been shaped to accept them and aligned to minimize erosion. Backfill shall be thoroughly compacted. No equipment shall be routed over a culvert until backfill depth is adequate to protect the culverts.
q.	As directed by the authorized officer, the holder shall submit a complete culvert list to reflect the drainage plan for the road. The list shall include, but not be limited to, size(s), lengths, and locations of the culverts.
r.	The minimum diameter for culverts shall be 18 inches.
s.	The holder shall construct low-water crossings in a manner that will prevent any blockage or restriction of the existing channel, including fish passage. Material removed shall be stockpiled for use in rehabilitation of the crossings.
t.	All roads and parking areas shall be constructed to provide drainage and minimize erosion. Culverts shall be installed if necessary to maintain drainage. Areas to be used for roads and parking shall be surfaced with aggregate as directed by the authorized officer.
u.	As directed by the authorizing officer, all road segments shall be winterized by providing a well-drained roadway by water baring, maintaining drainage, and any additional measures necessary to minimize erosion and other damage to the roadway or the surrounding public lands.
Operations and Maintenance of Approved Facilities	
v.	The holder shall construct, operate, and maintain the facilities, improvements, and structures within this right-of-way in strict conformity with the POD dated December, 2023. Any relocation, additional construction, or use that is not in accord with the approved POD, shall not be initiated without the prior written approval of the authorized officer. Upon request, a copy of the complete right-of-way grant, including all stipulations and approved POD, shall be made immediately available to the authorized officer on the right-of-way during construction, operation, maintenance, and termination. Noncompliance with the above requirement will be grounds for an immediate temporary suspension of activities if it constitutes a threat to public health and safety or the environment.
w.	The holder shall not modify the layout, locations, or types of equipment or facilities shown in Exhibit (B) of this grant without prior written approval from the authorized officer. Variances from the site plans or drawings shown in Exhibit (B) must be approved in writing before commencing with new designs or specifications.
x.	Specific sites as identified by the authorized officer (e.g. archaeological sites, areas with threatened and endangered species, or fragile watersheds) where construction equipment and vehicles shall not be allowed shall be clearly marked onsite by the holder before any construction or surface disturbing activities begin. The holder shall be responsible for assuring that construction personnel are well trained to recognize these markers and understand the equipment movement restrictions involved.

y.	Construction-related traffic shall be restricted to routes approved by the authorized officer. New access roads or cross-country vehicle travel will not be permitted unless prior written approval is given by the authorized officer. Authorized roads used by the holder shall be rehabilitated or maintained when construction activities are complete as approved by the authorized officer.
z.	Within 60 days after receipt of the authorized officer's written notification of damage or defects found in the structure or related facilities the holder will restore the facility to the originally constructed condition, using materials of equal or superior quality to those used in the original construction.
aa.	Should the holder fail to perform the required maintenance or repair within 60 days of receipt of the authorized officer's written notification to do so, BLM may perform the required maintenance or repair, or at the discretion of the authorized officer, remove the facility, at the holder's expense, including the administrative costs to BLM to effect any such action.
Wildland Fire Management	
bb.	The holder shall be responsible, as determined by the authorized officer, for fire suppression costs resulting from wildland fire caused by the holder, including employees, agents, and/or representatives, and by all clients, customers, and/or contractors under the holder's supervision or control.
cc.	The holder shall be responsible for informing employees, agents, representatives, clients, customers, and/or contractors of the current fire danger and any required precautions or restrictions that may be placed in effect by the BLM or the State of Nevada. The holder may obtain current fire conditions from the Sierra Front Interagency Fire Dispatch Center online or by telephone at (775) 883-5995.
dd.	The holder shall immediately report all wildland fires that start within the right-of-way to the Sierra Front Interagency Dispatch Center by telephone or to other local emergency response agencies if the Sierra Front Interagency Dispatch Center cannot be contacted.
ee.	When directed by the authorized officer, the holder shall prepare a fire prevention and suppression plan that shall be reviewed, modified, and approved, as appropriate, by the authorized officer. The holder shall take into account such measures for prevention and suppression of fire on the right-of-way and other public land used or traversed by the holder in connection with operations of the right-of-way. Project personnel shall be instructed as to individual responsibility in implementation of the plan.
ff.	During conditions of extreme fire danger, operations shall be limited or suspended in specific areas, or additional measures may be required by the authorized officer.
gg.	When requested by the authorized officer, the holder shall make his/her equipment already at the site with operators, temporarily available for fighting fires in the vicinity of the project. Payment for such services will be made at rates determined by the authorized officer.
Hazardous Materials and Petroleum Products	
hh.	The holder shall comply with all applicable Federal laws and regulations existing or hereafter enacted or promulgated. In any event, the holder shall comply with the Toxic Substances Control Act of 1976 as amended, 15 USC 2601 et seq. (1982) with regards to any toxic substances that are used, generated by or stored on the right-of-way or on facilities authorized under this grant. (See 40 CFR, Part 702-799 and especially,

	provisions on polychlorinated biphenyls, 40 CFR 761.1-761.193). Additionally, any release of toxic substances (leaks, spills, etc.) in excess of the reportable quantity established by 40 CFR, Part 117 shall be reported as required by the Comprehensive Environmental Response, Compensation, and Liability Act, section 102b. A copy of any report required or requested by any Federal agency or State government as a result of a reportable release or spill of any toxic substances shall be furnished to the Authorized Officer concurrent with the filing of the reports to the involved Federal agency or State government.
ii.	The holder agrees to indemnify the United States against any liability arising from the release of any hazardous substance or hazardous waste (as these terms are defined in the Comprehensive Environmental Response, Compensation and Liability Act of 1980, 42 U.S.C. 9601, et seq. or the Resource Conservation and Recovery Act of 1976, 42 U.S.C. 6901 at ag.) on the right-of-way (unless the release or threatened release is wholly unrelated to the holder's activity on the right-of-way. This agreement applies without regard to whether a release is caused by the holder, its agent, or unrelated third parties.
jj.	The holder is prohibited from discharging oil or other pollutants into or upon the navigable waters of the United States, adjoining shorelines, or the waters of the contiguous zone in violation of Section 311 of the Clean Water Act as amended, 33 U.S.C. 1321, and the regulations issued thereunder, or applicable laws of the State of Nevada and regulations issued thereunder. The holder shall give immediate notice of any such discharge to the authorized officer and such other Federal and State officials as are required by law to be given such notice.
Termination	
kk.	Six months prior to termination of the grant, the holder shall contact the authorized officer to arrange a joint inspection of the right-of-way. This inspection will be held to agree to an acceptable termination and rehabilitation plan. This plan shall include, but is not limited to, removal of facilities, drainage structures, or surface material, recontouring, topsoiling, or seeding. The authorized officer must approve the plan in writing prior to the holder's commencement of any termination activities. The holder shall be responsible for the cost and implementation of the approved rehabilitation plan.
Conveyance Out of Federal Ownership	
ll.	In the event that the public land underlying the right-of-way encompassed in this grant, or portion thereof, is conveyed out of Federal ownership and administration of the right-of-way or the land underlying the right-of-way is not being reserved to the United States in the patent/deed and/or the right-of-way is not within a right-of-way corridor being reserved to the United States in the patent/deed, the United States waives any right it has to administer the right-of-way, or portion thereof, within the conveyed land under Federal laws, statutes, and regulations, including the regulations in Title 43 CFR parts 2800 and 2880, as well as any rights to have the holder apply to the BLM for amendments, modifications, or assignments and for the BLM to approve or recognize such amendments, modifications, or assignments. At the time of conveyance, the patentee/grantee, and their successors and assigns, shall succeed to the interests of the United States in all matters relating to the right-of-way, or portion thereof, within the conveyed land and shall be subject to applicable State and local government laws, statutes, and ordinances. After conveyance, any disputes concerning compliance with

	the use and the terms and conditions of the right-of-way shall be considered a civil matter between the patentee/grantee and the holder.
Air Quality	
mm.	The holder shall meet Federal, State, and local emission standards for air quality.
Noxious Weeds and Pests	
nn.	The holder shall be responsible for controlling noxious and invasive weed infestations within the approved limits of the right-of-way and areas where infestations have spread from the right-of-way as a result of the holder's operations. The holder will consult with the authorized officer for planning acceptable weed control measures on all noxious and invasive weed infestations directly associated with the right-of-way.
oo.	The holder shall monitor the right-of-way at least annually during the growing season for the presence of noxious weed species listed on the Nevada Department of Agriculture <u>Nevada Noxious Weed List</u> . The holder shall maintain a record of monitoring dates, person/s completing the monitoring, qualifications of person/s completing the monitoring, species found, and the extent of infestations, e.g. number of plants found, acres of land that are infested, etc. If requested, the holder shall provide the above described monitoring data to the authorized officer annually or as specified by the authorized officer.
pp.	As soon as practicable after discovery of a noxious weed infestation, the holder shall report the infestation to the authorized officer by telephone. The holder shall develop and implement, as approved by the authorized officer, a noxious weed management plan to control the infestation through treatment (manual, mechanical, biological, chemical, prescribed fire, or other approved methods) and monitoring.
qq.	If vehicles and equipment are working in known noxious weed infestations, equipment will be washed prior to entering the project area to remove noxious weed propagules.
rr.	All equipment to be used in connection with this project during construction, operations, maintenance, and/or reclamation will first be cleaned thoroughly to minimize the introduction of new noxious weed species to the area. The holder shall provide written documentation of when and how equipment was cleaned at the request of the authorized officer.
ss.	In locations with known noxious weed infestations, all vehicles and equipment performing surface disturbing activities in connection with the right-of-way shall be thoroughly cleaned to reduce the spread of noxious weed species outside the right-of-way. The holder shall set up a cleaning station within the right-of-way in a location approved by the authorized officer. The holder shall provide written documentation of when and how equipment was cleaned at the request of the authorized officer.
tt.	All seed, hay, straw, gravel, or other earth materials used on the right-of-way shall be certified as noxious weed-free by the Nevada Department of Agriculture or equivalent state agency prior to being used on the right-of-way. The holder will provide documentation of noxious weed-free certification at the request of the authorized officer. If such certification cannot be obtained, the holder will consult with the authorized officer and obtain written approval of acceptable weed monitoring measures prior to using the materials on the right-of-way.
Pesticide or Biological Control Agent Use	

uu.	<p>The use of pesticides shall comply with Federal and state laws governing their proper usage, storage and disposal, and any limitations imposed by the Secretary of the Interior. Prior to the use of pesticides or biological control agents, the holder will obtain from the authorized officer written approval of a Pesticide Use Proposal/Plan (PUP) or Biological Control Agent Use Proposal/Plan (BCUP) showing the type and quantity of material to be used, pest(s) to be controlled, method of application, location of storage and disposed-of containers, and any other information deemed necessary by the authorized officer. Emergency use of pesticides shall be approved in writing by the authorized officer prior to such use and shall use BLM-approved mechanical methods or chemicals.</p>
-----	--

Cultural Resources

vv.	<p>The holder and persons working on their behalf shall not collect any historic (50 years or older) or prehistoric artifacts from federal lands. Collection of artifacts is a misdemeanor or felony under multiple federal laws, including the Archaeological Resources Protection Act of 1990 (16 U.S.C. 470aa-470mm; Public Law 96-95).</p>
-----	--

ww.	<p>The holder, or persons working on their behalf, shall immediately report to the authorized officer any cultural (historic or prehistoric site or object) or paleontological (fossil) resources discovered during the course of activities on federal land. The discovery shall be reported to the authorized officer's designated representative by telephone, followed by written confirmation sent to the address listed above. The holder shall stop all surface disturbing activities in the immediate area (minimum 100-foot radius) of such discovery and protect it until an evaluation of the discovery can be made by the authorized officer. In addition, the following shall occur:</p> <ul style="list-style-type: none"> • For discoveries of cultural resources other than human remains, the authorized officer will determine the significance of the discovery and what mitigation measures are necessary to comply with applicable laws. The authorized officer will notify the holder in writing when surface disturbing activities may resume. • For discoveries involving human remains, the holder or their representative shall stop all work within a 100-foot radius, then immediately notify the authorized officer's designated representative and the County Coroner by telephone, followed by written notification to the BLM. The holder must cover and protect the discovery location from photography; viewing by employees, contractors, the media, and the public; and further disturbance until the authorized officer notifies the holder in writing that work may resume. <p>The holder is responsible for the cost of protection, evaluation, and mitigation. Any decision on treatment and/or mitigation of discoveries will be made by the authorized officer after consulting with the holder and other parties, including Native American tribes, as required by law.</p>
-----	---

xx.	<p>The holder, their contractors, and any persons working on the holder's behalf shall not contact or provide information to the media about discoveries, shall not post pictures or information about discoveries via corporate or personal social media, and shall not take, or allow to be taken, any photographs other than those required to respond to the</p>
-----	--

	discovery (such as by law enforcement or the authorized officer's designated representative).
Cadastral Survey and Land Status	
yy.	The holder shall protect all survey monuments found within the right-of-way. Survey monuments include, but are not limited to, General Land Office and Bureau of Land Management Cadastral Survey Corners, reference corners, witness points, U.S. Coastal and Geodetic benchmarks and triangulation stations, military control monuments, and recognizable civil (both public and private) survey monuments. In the event of obliteration or disturbance of any of the above, the holder shall immediately report the incident, in writing, to the authorized officer and the respective installing authority if known. Where General Land Office or Bureau of Land Management right-of-way monuments or references are obliterated during operations, the holder shall secure the services of a registered land surveyor or a Bureau cadastral surveyor to restore the disturbed monuments and references using surveying procedures found in the <u>Manual of Surveying Instructions for the Survey of the Public Lands in the United States</u> , latest edition. The holder shall record such survey in the appropriate county and send a copy to the Authorized Officer. If the Bureau cadastral surveyors or other Federal surveyors are used to restore the disturbed survey monument, the holder shall be responsible for the survey cost.
Wildlife – General	
zz.	The holder shall notify the authorized officer and the Nevada Department of Wildlife within 24 hours of any injuries and/or mortalities of special status wildlife within the right-of-way during construction, operation, maintenance, or reclamation /decommissioning activities.
aaa.	The holder shall remove only the minimum amount of vegetation necessary for the construction or maintenance of facilities. Topsoil shall be conserved during excavation and reused as cover on disturbed areas to facilitate regrowth of vegetation.
bbb.	Construction holes left open overnight shall be covered. Covers shall be secured in place and shall be strong enough to prevent livestock or wildlife from falling into the hole or trench. If adequate cover cannot be installed, effective escape ramps shall be installed to allow livestock or wildlife to avoid entrapment.
ccc.	All mammals, reptiles, and amphibians shall be removed from construction holes or trenches prior to backfilling.
ddd.	Open-top vertical pipes, including vents, stacks, fence posts, and survey markers, of any diameter, shall be securely capped or screened to prevent unintentional trapping of wildlife.
eee.	Artificial facility lighting shall be shielded to direct light towards the ground within the approved facility boundary.
fff.	All guy wires shall be effectively marked to be visible to birds, wild horses and burros, and big game animals.
ggg.	Fences, gates, brace panels, and cattleguards affected by the holder's use of the right-of-way shall be reconstructed to appropriate standards and/or specifications as determined by the authorized officer.
hhh.	Fences, gates, brace panels, and cattleguards affected by the holder's use of the right-of-way shall be re-constructed to appropriate BLM standards and/or specifications as

	determined by the authorized officer. The holder shall use the wire spacing standard shown in Illustration 2 of BLM Handbook H-1741-1 (Fencing) for "Combination of Cattle (Requiring Greater Restriction of Livestock Movements) With Deer, Elk, Moose, or Antelope" when constructing or re-constructing fences which control the movement of livestock. The holder shall disconnect fence wires from all fence posts between bracing structures prior to stretching wires to ensure adequate tensioning. When re-constructing or modifying wire fences, the holder shall repair or replace bracing structures to ensure the integrity of the fence.
Wildlife – Migratory Birds and Raptors	
iii.	The holder shall report observed raptor or other bird nests on existing facilities to the authorized officer as soon as practicable. The holder may be directed by the authorized officer to remove nests from facilities (e.g. power lines, communications towers, buildings, etc.) outside of nesting seasons.
Visual Resource Management	
jjj.	Colors on all above-ground structures not subject to safety requirements, such as buildings, antennas, towers, and microwave dishes, shall be earth/vegetative tones compatible with existing natural site features and complementary colors. The holder shall use Standard Environmental Color Chart CC-001 (June 2013 or most recent edition) to obtain paint colors to use on the right-of-way. Copies of Standard Environmental Color Chart CC-001 may be obtained from the BLM at the address listed above. The holder shall not use Carlsbad Canyon, Juniper Green, or Carob Brown without prior written authorization from the authorized officer.
kkk.	Paint colors shall not be more glossy than a semi-gloss finish. Paint colors that have faded from sun exposure shall be repainted to restore the approved color from Standard Environmental Color Chart CC-001.
lll.	Structures which cannot be painted or require a non-compatible color to operate in accordance with manufacturer specifications shall be immediately reported to the authorized officer. The authorized officer will work with the holder to establish alternate means of reducing the visual impact, such as constructing a screening fence to block the view or installing a cover. Alternative means to reduce visual impacts shall be approved by the BLM prior to use on the right-of-way.
Soil	
mmm.	No construction or routine maintenance activities shall be performed during periods when the soil is too wet to adequately support construction equipment. If such equipment creates ruts in excess of three (3) inches deep, the soil shall be deemed too wet to adequately support construction equipment.
nnn.	Earthwork and grading, including road surfacing, drainage structures, and ditch profiles, shall not block natural drainage systems nor change the character of natural drainage systems. Earthwork, grading, erosion control structures (e.g. culvert pipes, wing ditches, etc.), and stream crossings, including crossings with either perennial or intermittent flows, shall not cause excessive siltation that damages fish and/or wildlife habitat in waterways or water bodies.